



Goodwyn Mills Cawood

Charleston Technology Center
997 Morrison Drive
Suite 102
Charleston, SC 29403
www.gmcnetwork.com

ADDENDUM NO.1
Spartanburg Community College Gaines Building Office Renovation
GMC #ACST250006
OSE #H59-N322-JM
131 Community College Drive Spartanburg, SC 29303
August 11, 2025

The following items shall take precedence over the drawings and specifications for the above named project and shall become a part of the contract documents. Where any item called for in the specifications, or indicated on the drawings, is not supplemented hereby, the original requirements shall remain in effect. Where any original item is amended, voided, or superseded hereby, the provisions of such item not specifically amended, voided, or superseded shall remain in effect.

General:

1. Bidders are hereby advised that information from bid documents which are not received from the Architect are not legitimate and the bidder accepts full responsibility for any differences. GMC has not authorized the scanning of the documents. Bidders should be aware that the plans are copyrighted and any unlawful use is subject to legal action. Bidders are further advised that the use of partial bid documents is not recommended and bidders will be responsible for any discrepancies which might have been avoided had a full set of documents been reviewed.

2. The primary point of contact for site access is:

David W. Barber, SCEM/EL
Project Manager, Campus Operations
Spartanburg Community College
Office: (864) 592-4960

3. All questions must be submitted in writing. All responses will be made in the form of addenda to the bid documents.
4. Substitutions: Requests for substitutions must be submitted to the A/E at least 10 days prior to the bid date, which is **August 11th**. A/E shall include in an addendum the approved substitutions.
5. No addenda will be issued later than 5 business days prior to the Bid Date which will be: **August 13th**. Deadline for questions for final Addenda is **August 12th**.
6. Fire Alarm Systems - Contractor to coordinate with the following contact for Fire Alarm Systems:

Ken McEntyre
Johnson Controls

7. Drawings:
 - All architectural sheets reissued to display the correct Goodwyn Mills Cawood, LLC company stamp.
 - A1.01
 - Door R8-A size has been revised.
 - Hallway R8 flooring has been changed to CPT-1.
 - Mullion height in Storefront Section Detail / D9 has been revised.



Attachments:

1. Drawings:

- T1
- G1.03
- G1.11
- G2.00
- G2.01
- D1.01
- A1.01
- A2.01
- A8.01


END of ADDENDUM #1

SCC - GAINES BUILDING OFFICE RENOVATION


SPARTANBURG COMMUNITY COLLEGE
131 COMMUNITY COLLEGE DRIVE,
SPARTANBURG, SC 29303

ISSUE: BID DOCUMENTS
ISSUE DATE: 06/23/2025

GOODWYN MILLS CAWOOD, LLC	ARCHITECTURE, INTERIORS
STEPHENS ENGINEERING & CONSULTING, LLC	MECHANICAL & PLUMBING ENGINEERING
MATRIX ENGINEERING, INC.	ELECTRICAL ENGINEERING

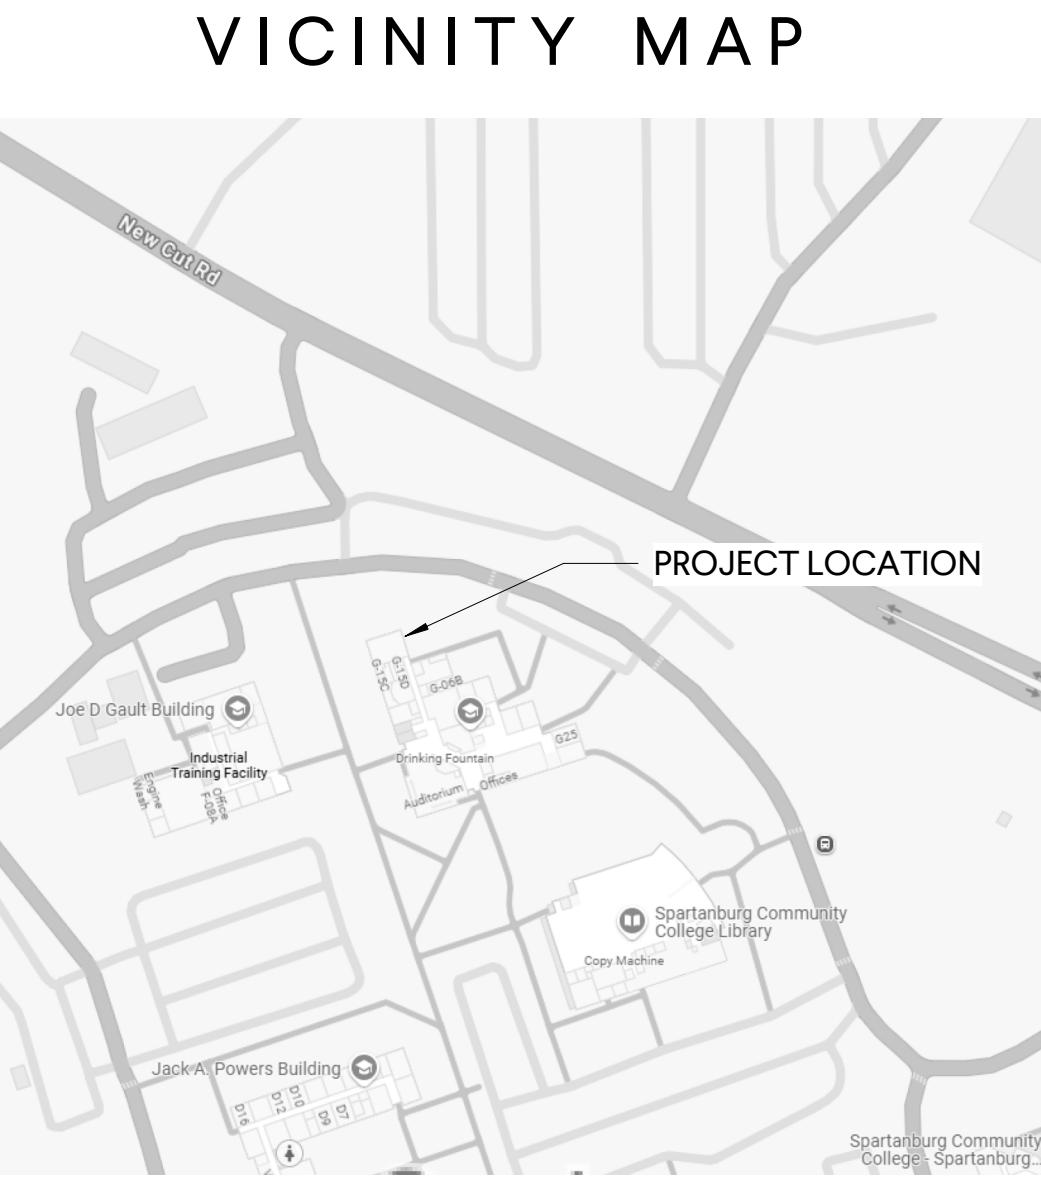

LOCATION MAP

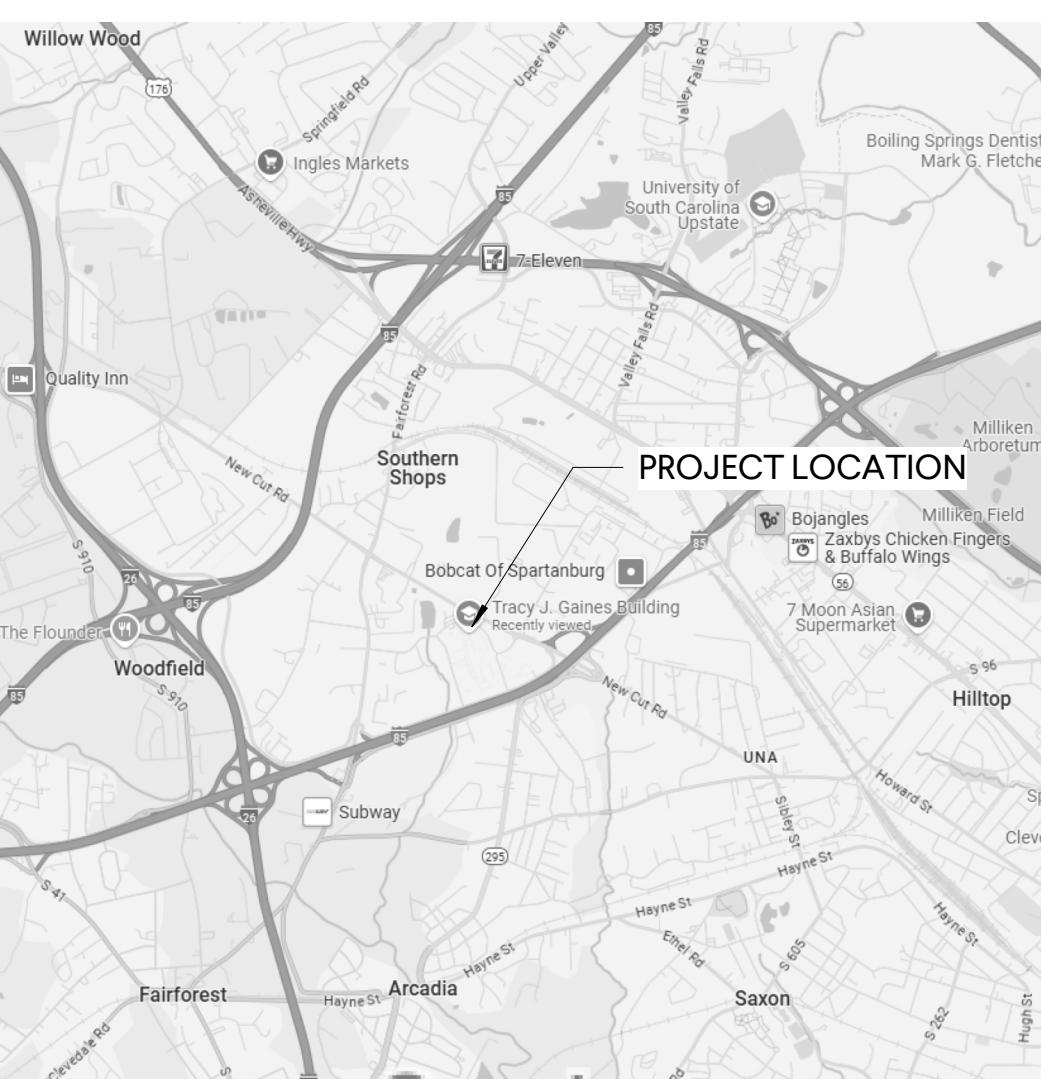

PLAN
NORTH

TRUE
NORTH

DRAWING INDEX

DWG. NO.	DRAWING NAME
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0.0 GENERAL	
T1	TITLE SHEET
G1.03	GENERAL INFORMATION
G1.11	ACCESSIBILITY DATA
G2.00	LIFE SAFETY - CODE ANALYSIS
G2.01	LIFE SAFETY PLAN - LEVEL 1

2.0 DEMOLITION	
D1.01	DEMOLITION PLAN AND RCP

3.0 ARCHITECTURE	
A1.01	FLOOR PLAN & DOOR SCHEDULE
A2.01	REFLECTED CEILING PLAN
A8.01	FINISH LEGEND & SCHEDULE



4.0 MECHANICAL	
M1.1	HVAC PLANS

5.0 PLUMBING	
P1.1	PLUMBING PLANS

6.0 ELECTRICAL	
E001	GENERAL NOTES, LEGENDS, FIXTURE SCHEDULE, COMCHECK & ELECTRICAL SPECS
E002	PANEL SCHEDULES
E003	DEMOLITION PLAN & RCP DEMOLITION PLAN
E200	POWER PLAN & MECHANICAL POWER PLAN
E300	LIGHTING PLAN & FIRE ALARM PLAN

SCC - GAINES BUILDING OFFICE RENOVATION
131 COMMUNITY COLLEGE DRIVE,
SPARTANBURG, SC 29303

GMC # ACST250006

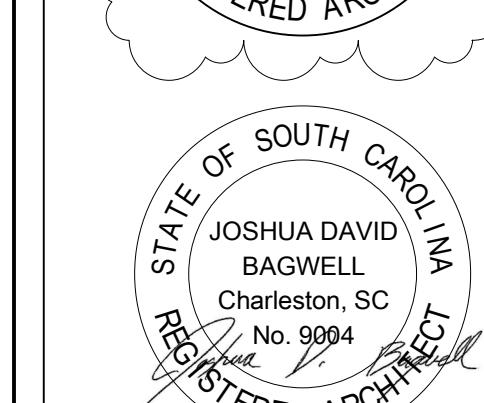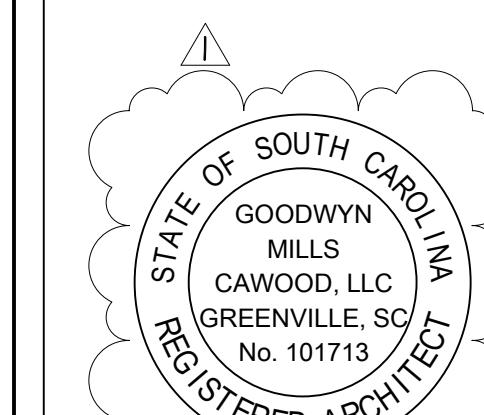

TITLE SHEET

T1

Goodwyn Mills Cawood, LLC
117 Wellborn Street
Greenville, SC 29601
T 864-527-0460
GMC NETWORK.COM

ISSUE DATE	BID DOCUMENTS	ADDRESSUM
06/23/2025	08/01/2025	





DRAWN BY:	CRG

CHECRED BY:	JDB

ABBREVIATIONS

ACC	ACCESSIBLE	EA	EACH	K	THOUSAND	REQD	REQUIRED	STRUCTURE ABOVE	STRUCTURE ABOVE	NUMBERED NOTES
ACI	AMERICAN CONCRETE INSTITUTE	EF	EACH FACE	KIP	1000 #	RET	RETAINING	TRUSS, JOIST, OR STEEL DECKING AS INDICATED)	TRUSS, JOIST, OR STEEL DECKING AS INDICATED)	1.1 METAL STUDS 16 OC. DOUBLE-STUD JAMB FULL HT. AT DOOR OPENINGS
AC	ACOUSTICAL CEILING TILE	EFS	EXTERIOR INSULATION SYSTEM	KJ	1000 # SQ IN	REV	REVISION (S), REVISED	1.5 CONTINUOUS TOP TRACK (0.032" METAL THICKNESS)	1.7 STUD BRACING MIN. 48 IN. OC (24 OC AT WALL-HUNG CABINETS)	
ADD	ADDITION	EJ	EXPANSION JOINT	KSI		RH	RIGHT HAND		2.1 ONE LAYER 5/8 IN. GYPSUM BD	
AFF	ABOVE FINISH FLOOR	ELEV	ELEVATION / ELEVATOR	LAM	LAMINATE (D)	RJ	RECESSED JOINT		3.1 SOUND ATTENUATION BATT INSULATION. 3.5" THICK	
ALT	ALTERNATE	ELEC	ELECTRIC (ALL)	LF	LINEAR FOOT	RM	ROOM		3.5 ACOUSTICAL CEILING PANELS. WHERE PANELS W/ COMBINED NRC/ICAC RATINGS OF .7035 (OR BETTER) ARE USED, DRAPE INSULATION MAY BE OMITTED	
ALUM	ALUMINUM	ENGR	ENGINEER	LAB	LENGTH, ANGLE	ROW	RIGHT OF WAY		3.6 ACOUSTICAL SEALANT JOINT. PROVIDE CONT. BEAD UNDER EACH LAYER GYPSUM BD	
APPROX	APPROXIMATE	EOP	EDGE OF PAVEMENT	LAV	LABORATORY	RTU	ROOF TOP UNIT		3.10 EXTEND GYPSUM BOARD TO TOP OF TRACK TO ESTABLISH A DRAFT STOP ASSEMBLY. CONDUIT TURNOUTS AND ELECTRICAL BOXES MUST STAND CLEAR OF MET. STUDS TO ALLOW FOR APPLICATION OF UNINTERRUPTED GYPSUM MEMBRANE	
ARCH	ARCHITECT (URAL)	EOS	EDGE OF SLAB	LH	LEFT HAND				3.11 STEEL BENT PLATE END WALL SUPPORT. SEE JAMBEND POST DETAIL ON G1.22	
ADJ	ADJACENT	EW	EACH WAY	LL	LIVE LOAD				3.12 WALL CAP. SEE DETAILS ELSEWHERE ON THESE DRAWINGS	
B/B	BACK-TO-BACK	EWC	ELECTRIC WATER COOLER	LLH	LONG LEG HORIZONTAL					
BC	BASE OF CURB	EXH	EXHAUST	LP	LONG LEG VERTICAL					
BD	BOARD	EXIST	EXISTING	LT GA	LOW POINT					
J	BUILDING	EXP	EXPOSED	LT	LIGHT GAUGE					
BLDG	BLOCKING	EXPN	EXPANSION		LIGHT					
BLKG	BENCHMARK	EXT	EXTERIOR							
BM	BOTTOM	FBO	FURNISHED BY OTHERS	MATL	MATERIAL					
BOT	BEARING	FD	FLOOR DRAIN	MAX	MAXIMUM					
BRG	BASEMENT	FEC	FIRE EXTINGUISHER & CABINET	MC	MISCELLANEOUS CHANNEL					
BSMT	BUILT-UP ROOF	FFP	FINISH FLOOR ELEVATION	MECH	MECHANICAL					
BUR	BOTTOM OF WALL	FHC	FINISH FACE OF WALL	MANUF	MEZZANINE					
BOW	BETWEEN	F/F	FIRE HOSE & CABINET	MIN	MANUFACTURE (R)					
BW		FL	FACE TO FACE	MH	MANHOLE					
CAB	CABINET	FLG	FLOOR	MIN	MINIMUM					
CB	CATCH BASIN	FND	FOUNDATION	MULL	MASONRY OPENING					
C/C	CENTER TO CENTER	FO	FACE OF	NIC	NOT IN CONTRACT					
CD	CORE DECK	FOB	FACE OF BRICK	NO	NUMBER					
CF	CUBIC FOOT	FOC	FACE OF CONCRETE	NOM	NOMINAL					
CFCL	CONTRACTOR FURNISHED,	FOF	FACE OF FINISH	NTS	NOT TO SCALE					
CI	CONTRACTOR INSTALLED	FOM	FACE OF MASONRY	O/H	OVERHEAD					
CIP	CAST IRON	FO5	FACE OF STUD	OC	ON CENTER (S)					
CJ	CAST IRON PIPE	FR	FRAME (ED), (ING)	OCC	OCUPANT (S)					
CLG	CONSTRUCTION OR CONTROL JOINT	FRT	FIRE RETARDANT TREATED	OD	OUTSIDE DIAMETER					
CLO	CEILING	FT	FOOT/FEET	OFCL	OWNER FURNISHED,					
CLR	CLOSET	FTG	FOOTING	OH	OPPOSITE HAND					
CMP	CLEAR (ANCE)	GA	GAUGE	OPG	OPENING					
CMU	CORRUGATED METAL PIPE	GB	GALVANIZED	OPP	OPPOSITE					
CO	CONCRETE MASONRY UNIT	GHM	GALVANIZED METAL	PJ	PRECAST JOINT					
COL	CLEAN OUT	GI	GALVANIZED IRON	PL	PROPERTY LINE, PLATE					
CONC	COLUMN	GWB	GYPSUM WALL BOARD	PLAM	PLASTIC LAMINATE					
CONN	CONNECTION	GYP	GYPSUM	PNT	PAINT (ED)					
CONST	CONTINUOUS OR CONTINUE	H	HEIGHT	PREFAB	PREFABRICATED					
COORD	COORDINATE	HC	HANDICAP	PREFIN	PREFAMUFACTURED					
CPT	CARPET (ED)	HM	HOLLOW METAL	PREMANUF	PREMANUFACTURED					
CSMU	CALCIUM SILICATE MASONRY UNIT	HOD	HIGHEST OPERABLE DEVICE	PSF	POUNDS PER SQUARE FOOT					
CT	CERAMIC TILE	HP	HORIZONTAL	PSI	POUNDS PER SQUARE INCH					
CW	CURTAIN WALL	H55	HOLLOW POINT/HORSE POWER	PT	POINT / PRESSURE TREATED /					
D	DRYER	HT	HOLLOW STRUCTURAL STEEL	PVC	POINT OF TANGENCY					
DBL	DOUBLE	HVAC	HEIGHT	PVMT	POLYVINYL CHLORIDE					
DET	DEMOLISH OR DEMOLITION	HW	HEATING / VENTILATION / AIR CONDITIONING	PWD	PAVEMENT					
DET	DETAIL	HT	HARDWARE	QT	PLYWOOD					
DH	DOUBLE HUNG				WALL TO WALL					
DIA	DIAMETER				WELDED WIRE FABRIC					
DIM	DIAGONAL				WITH					
DL	DIMENSION				WITHOUT					
DS	DEAD LOAD									
DWG	DOWNSPOUT									
DF	DRAWING									
	DRINKING FOUNTAIN									


ANNOTATION SYMBOLS & TAGS

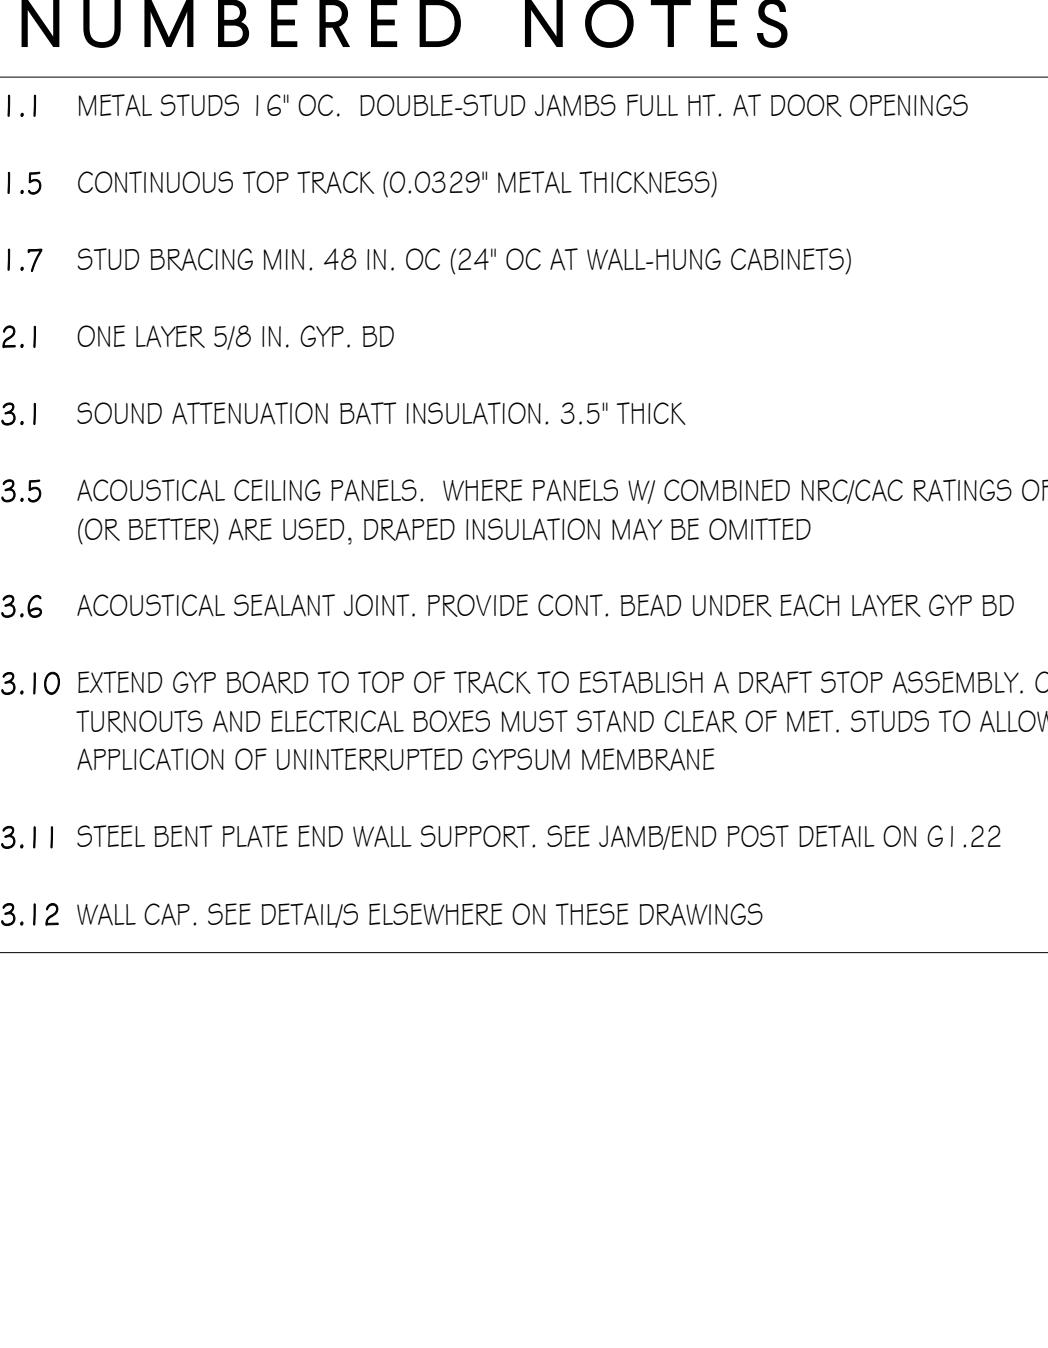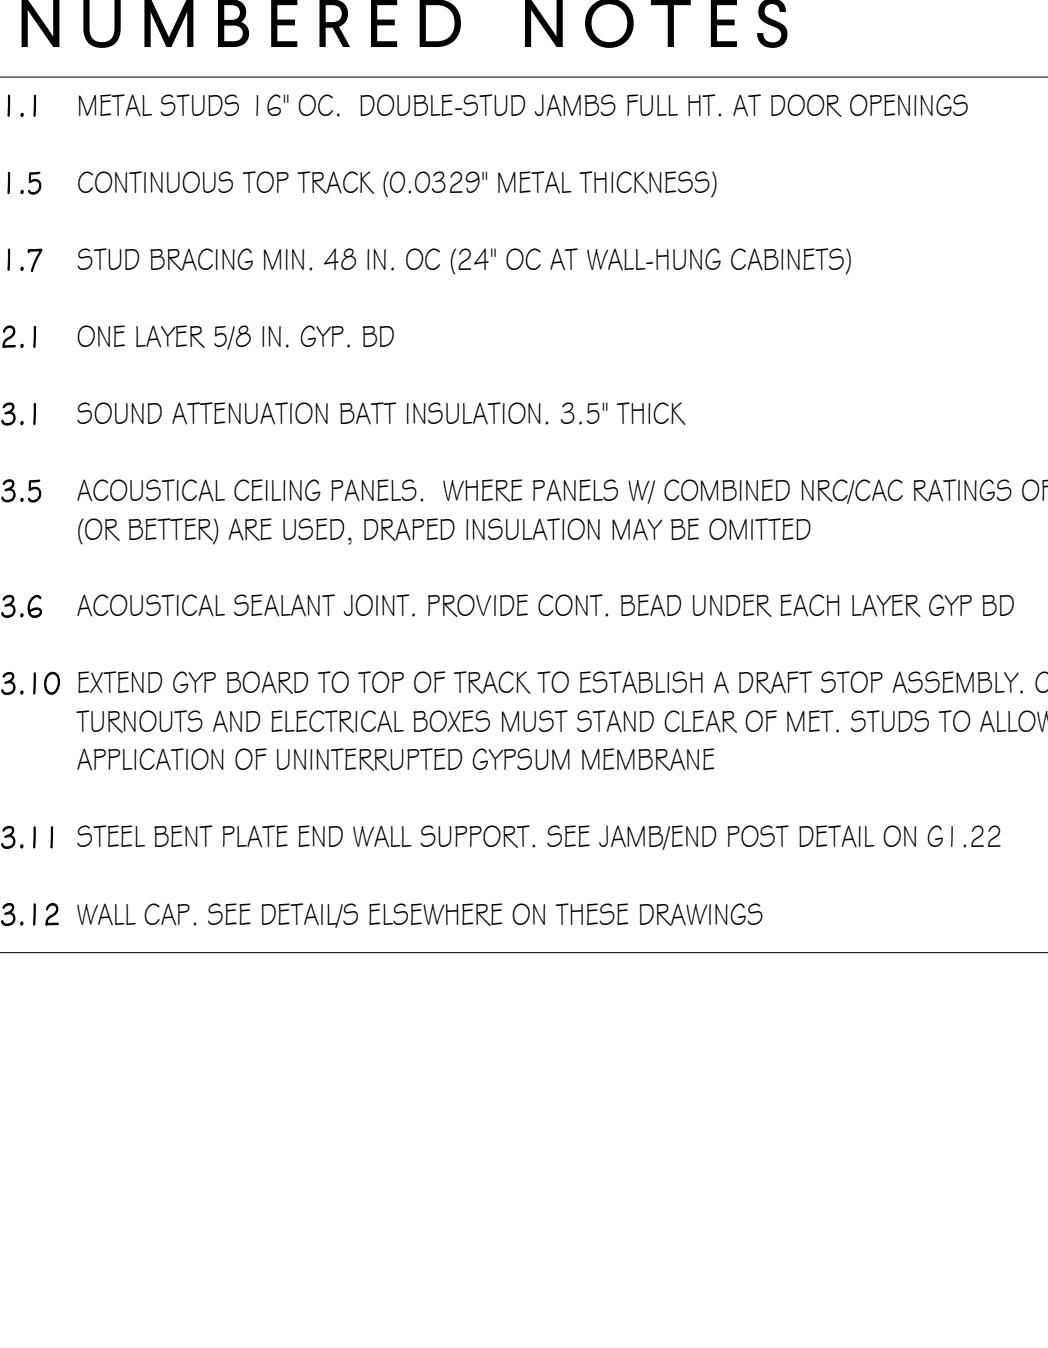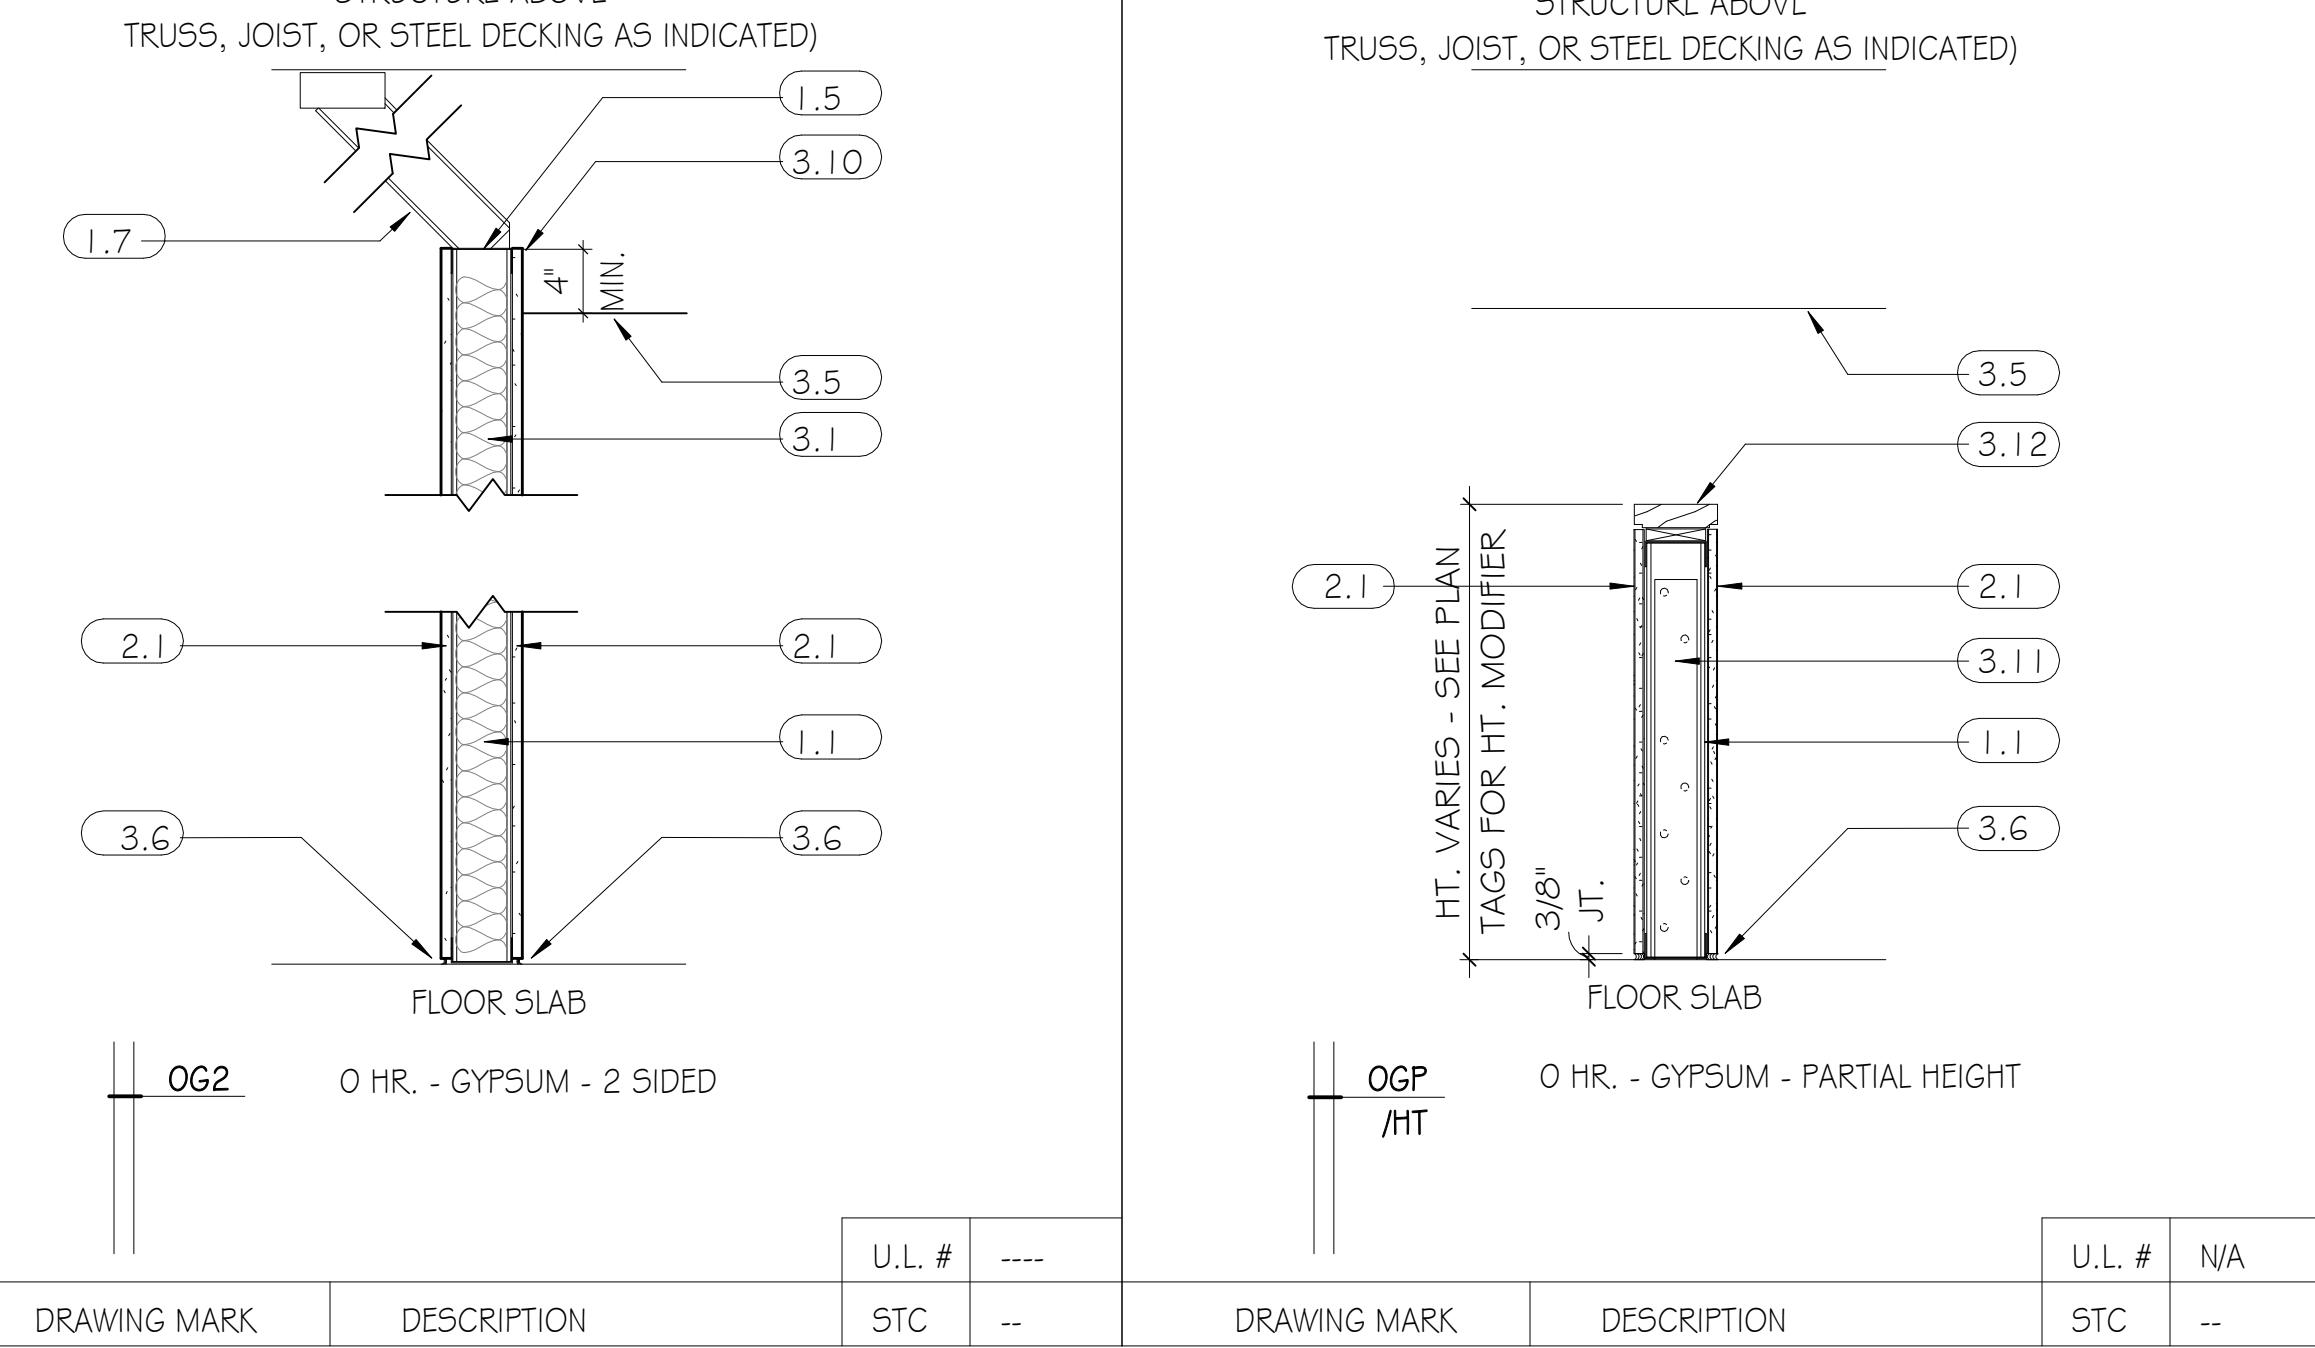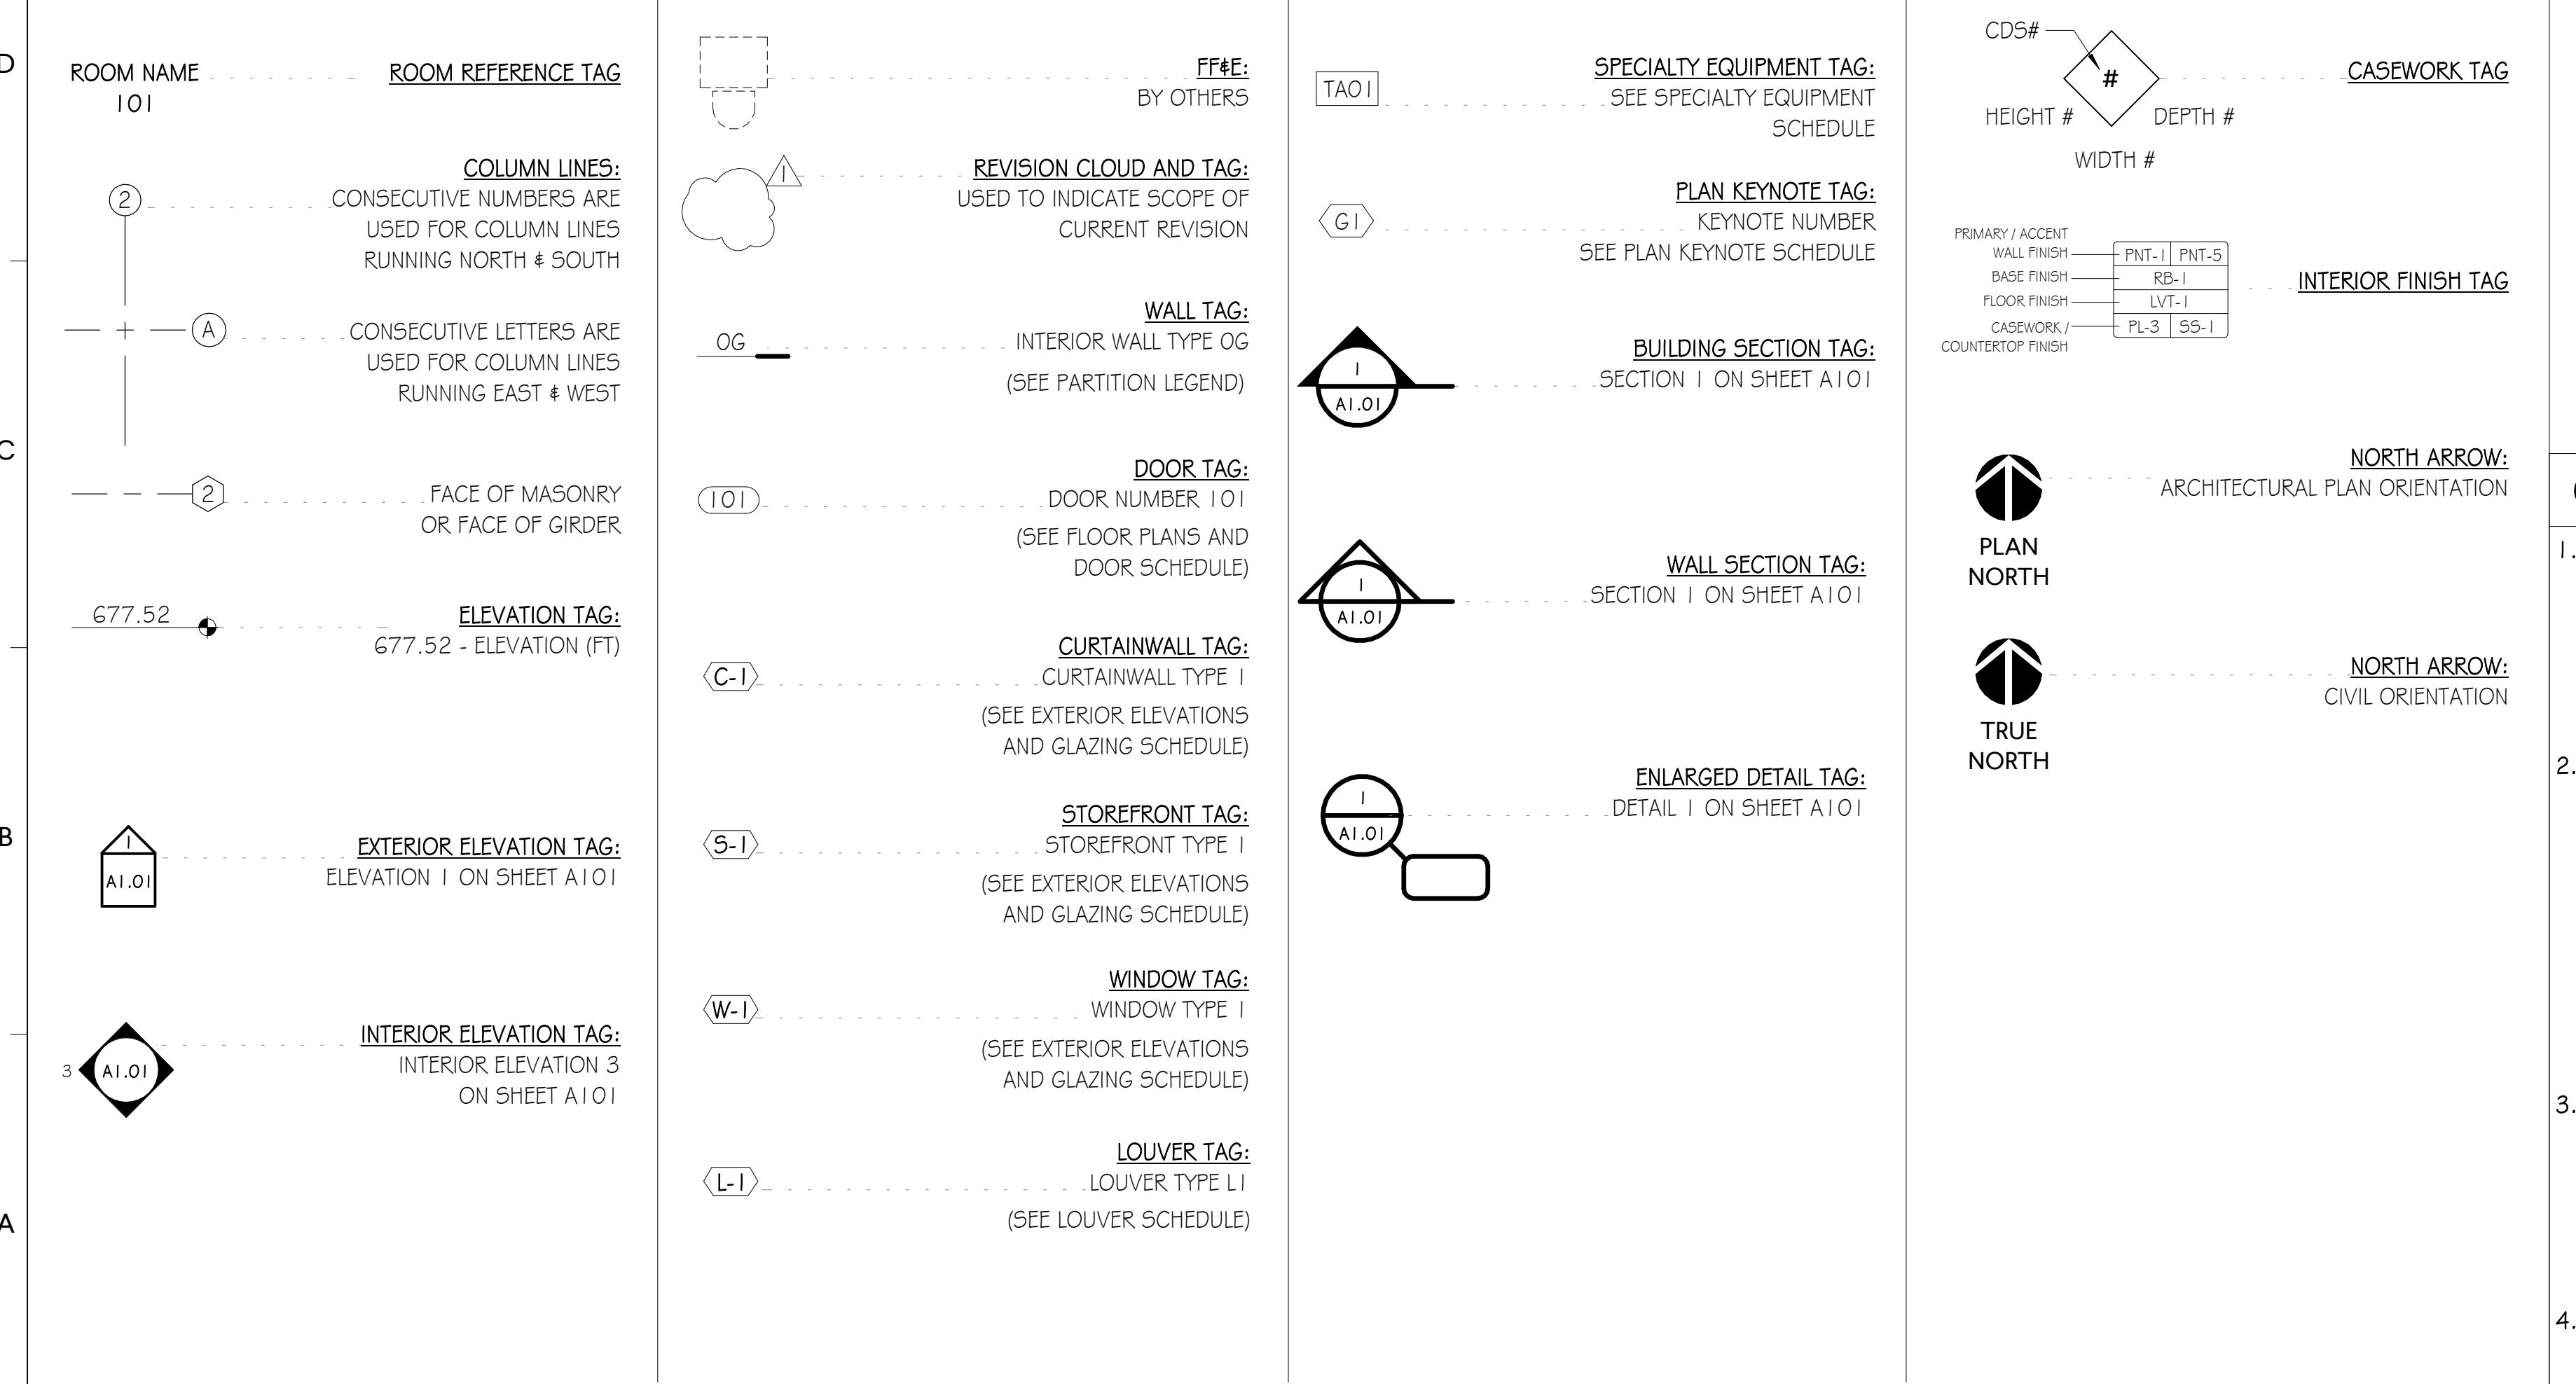













Goodwyn Mills Cawood, LLC
117 Wellborn Street
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T 864-527-0460
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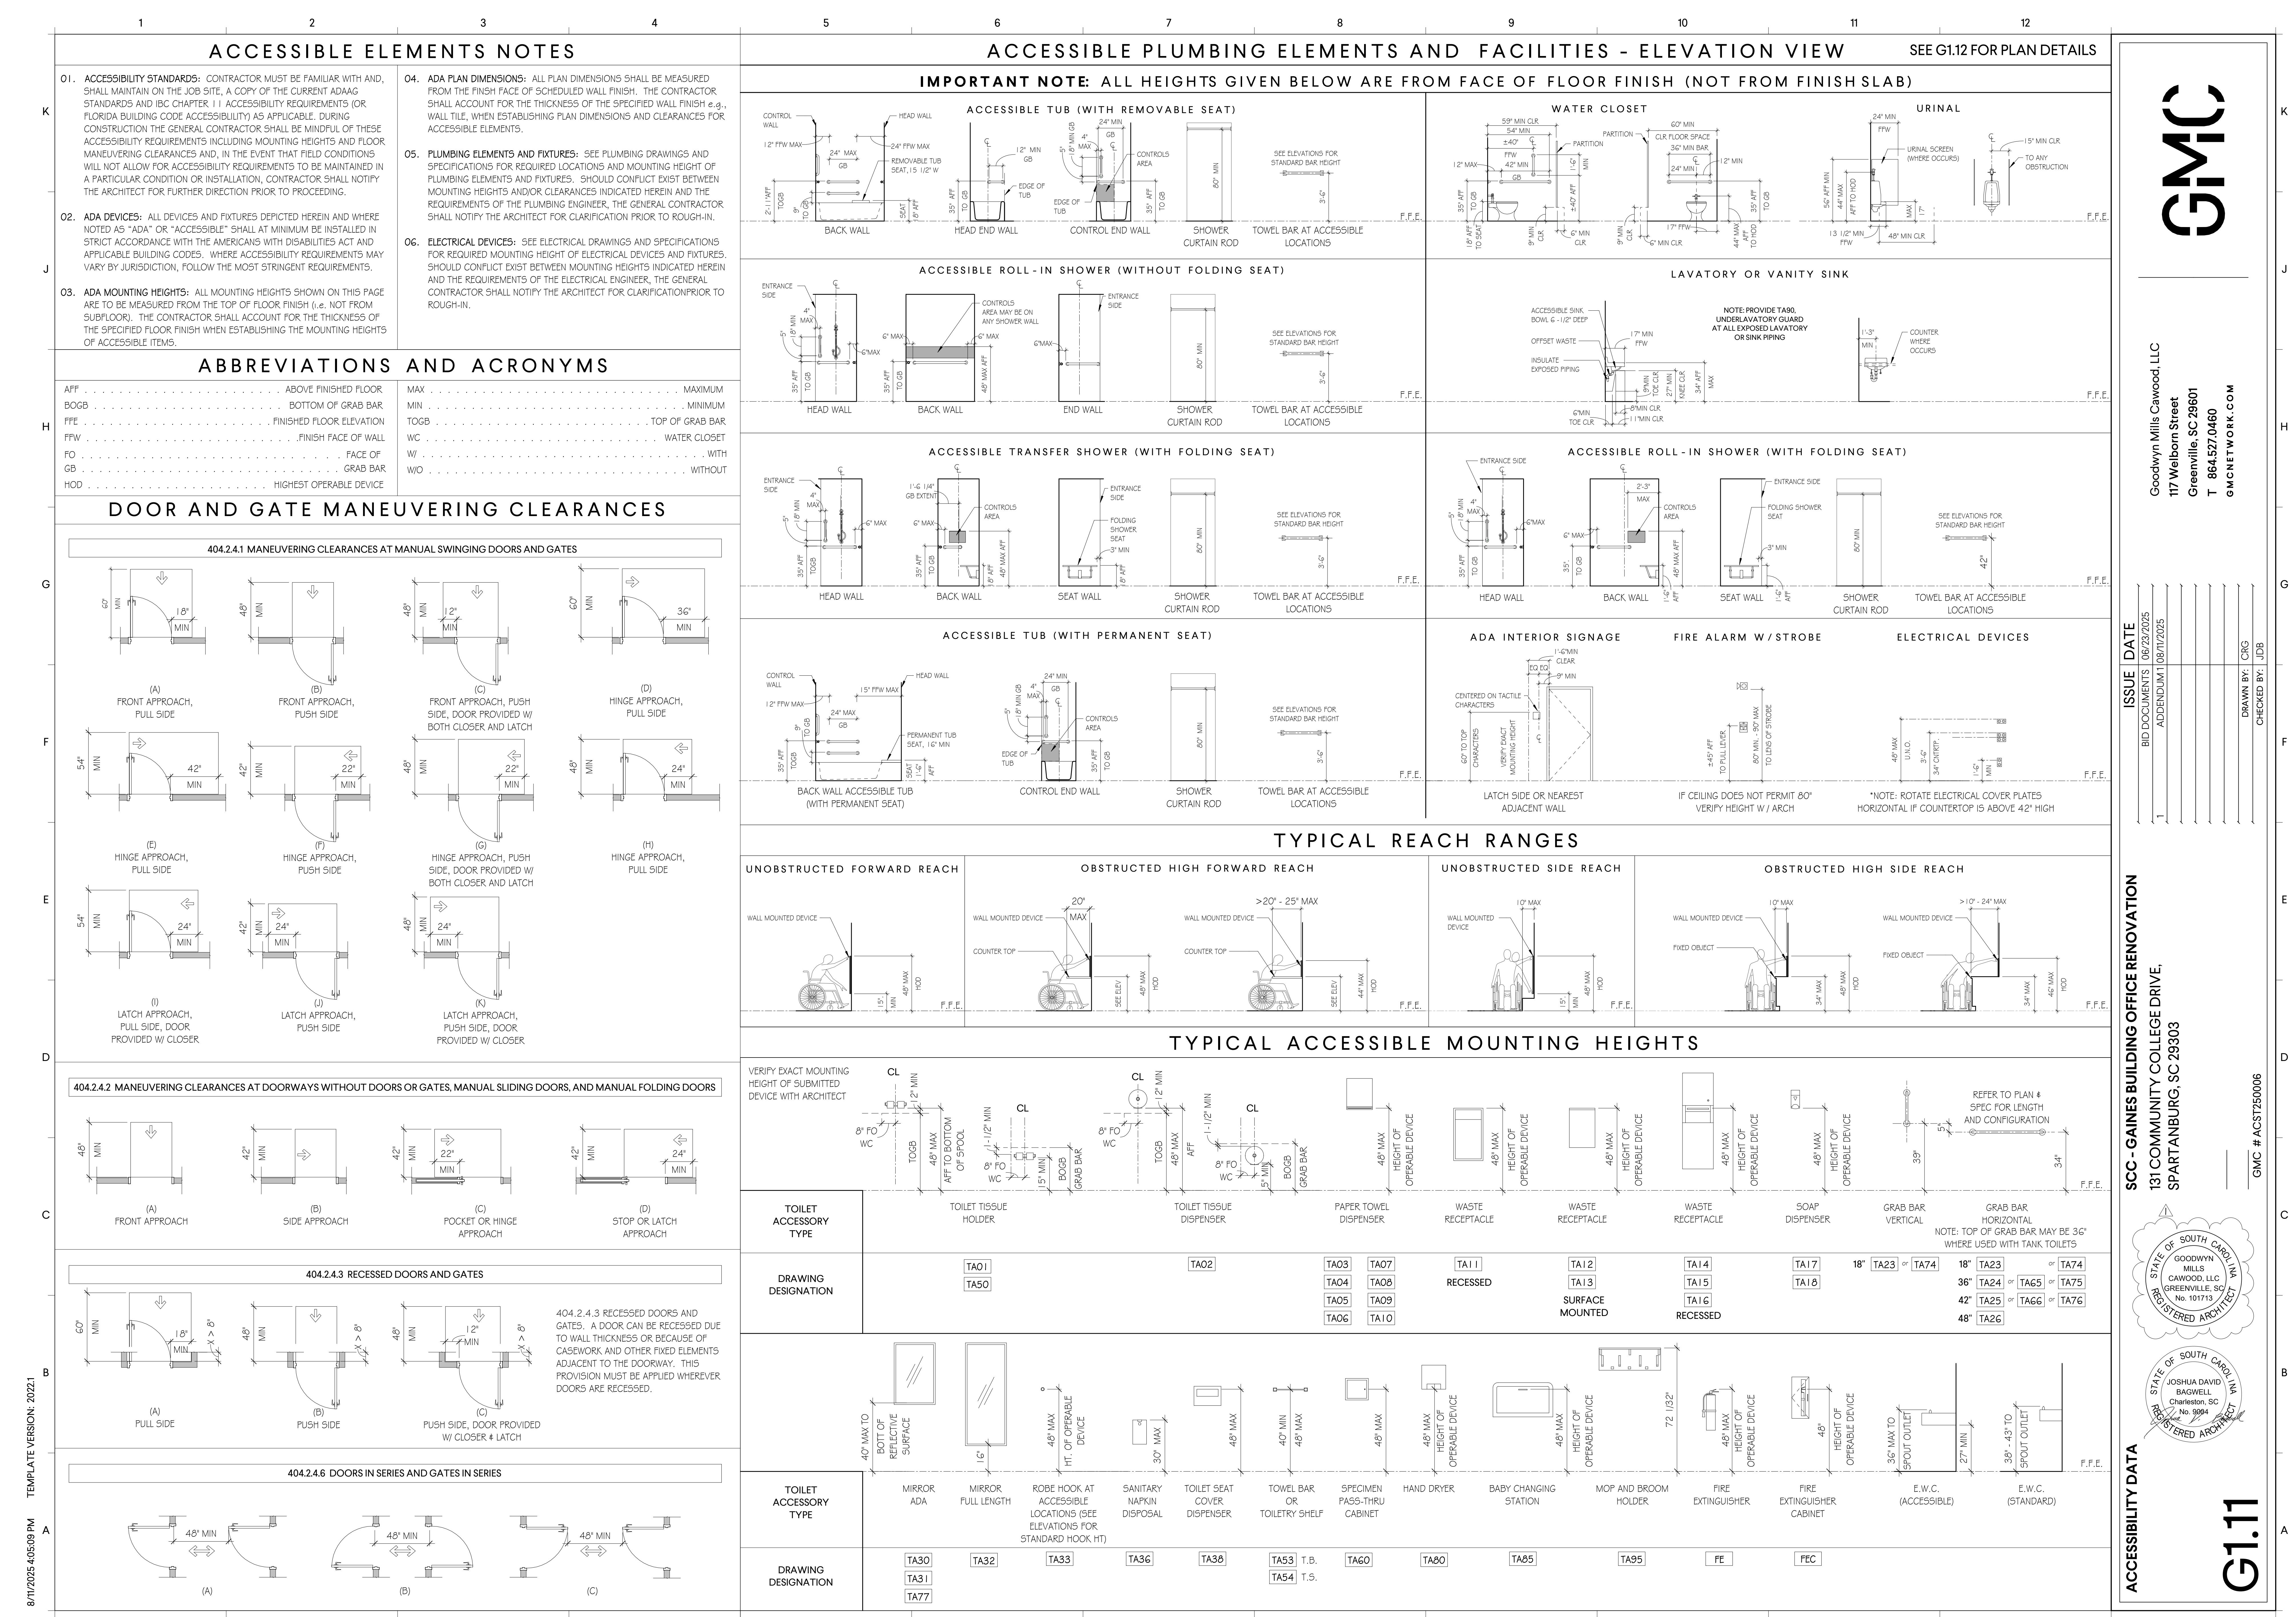
ISSUE DATE
BID DOCUMENTS 06/23/2025
ADDITIONAL 08/11/2025
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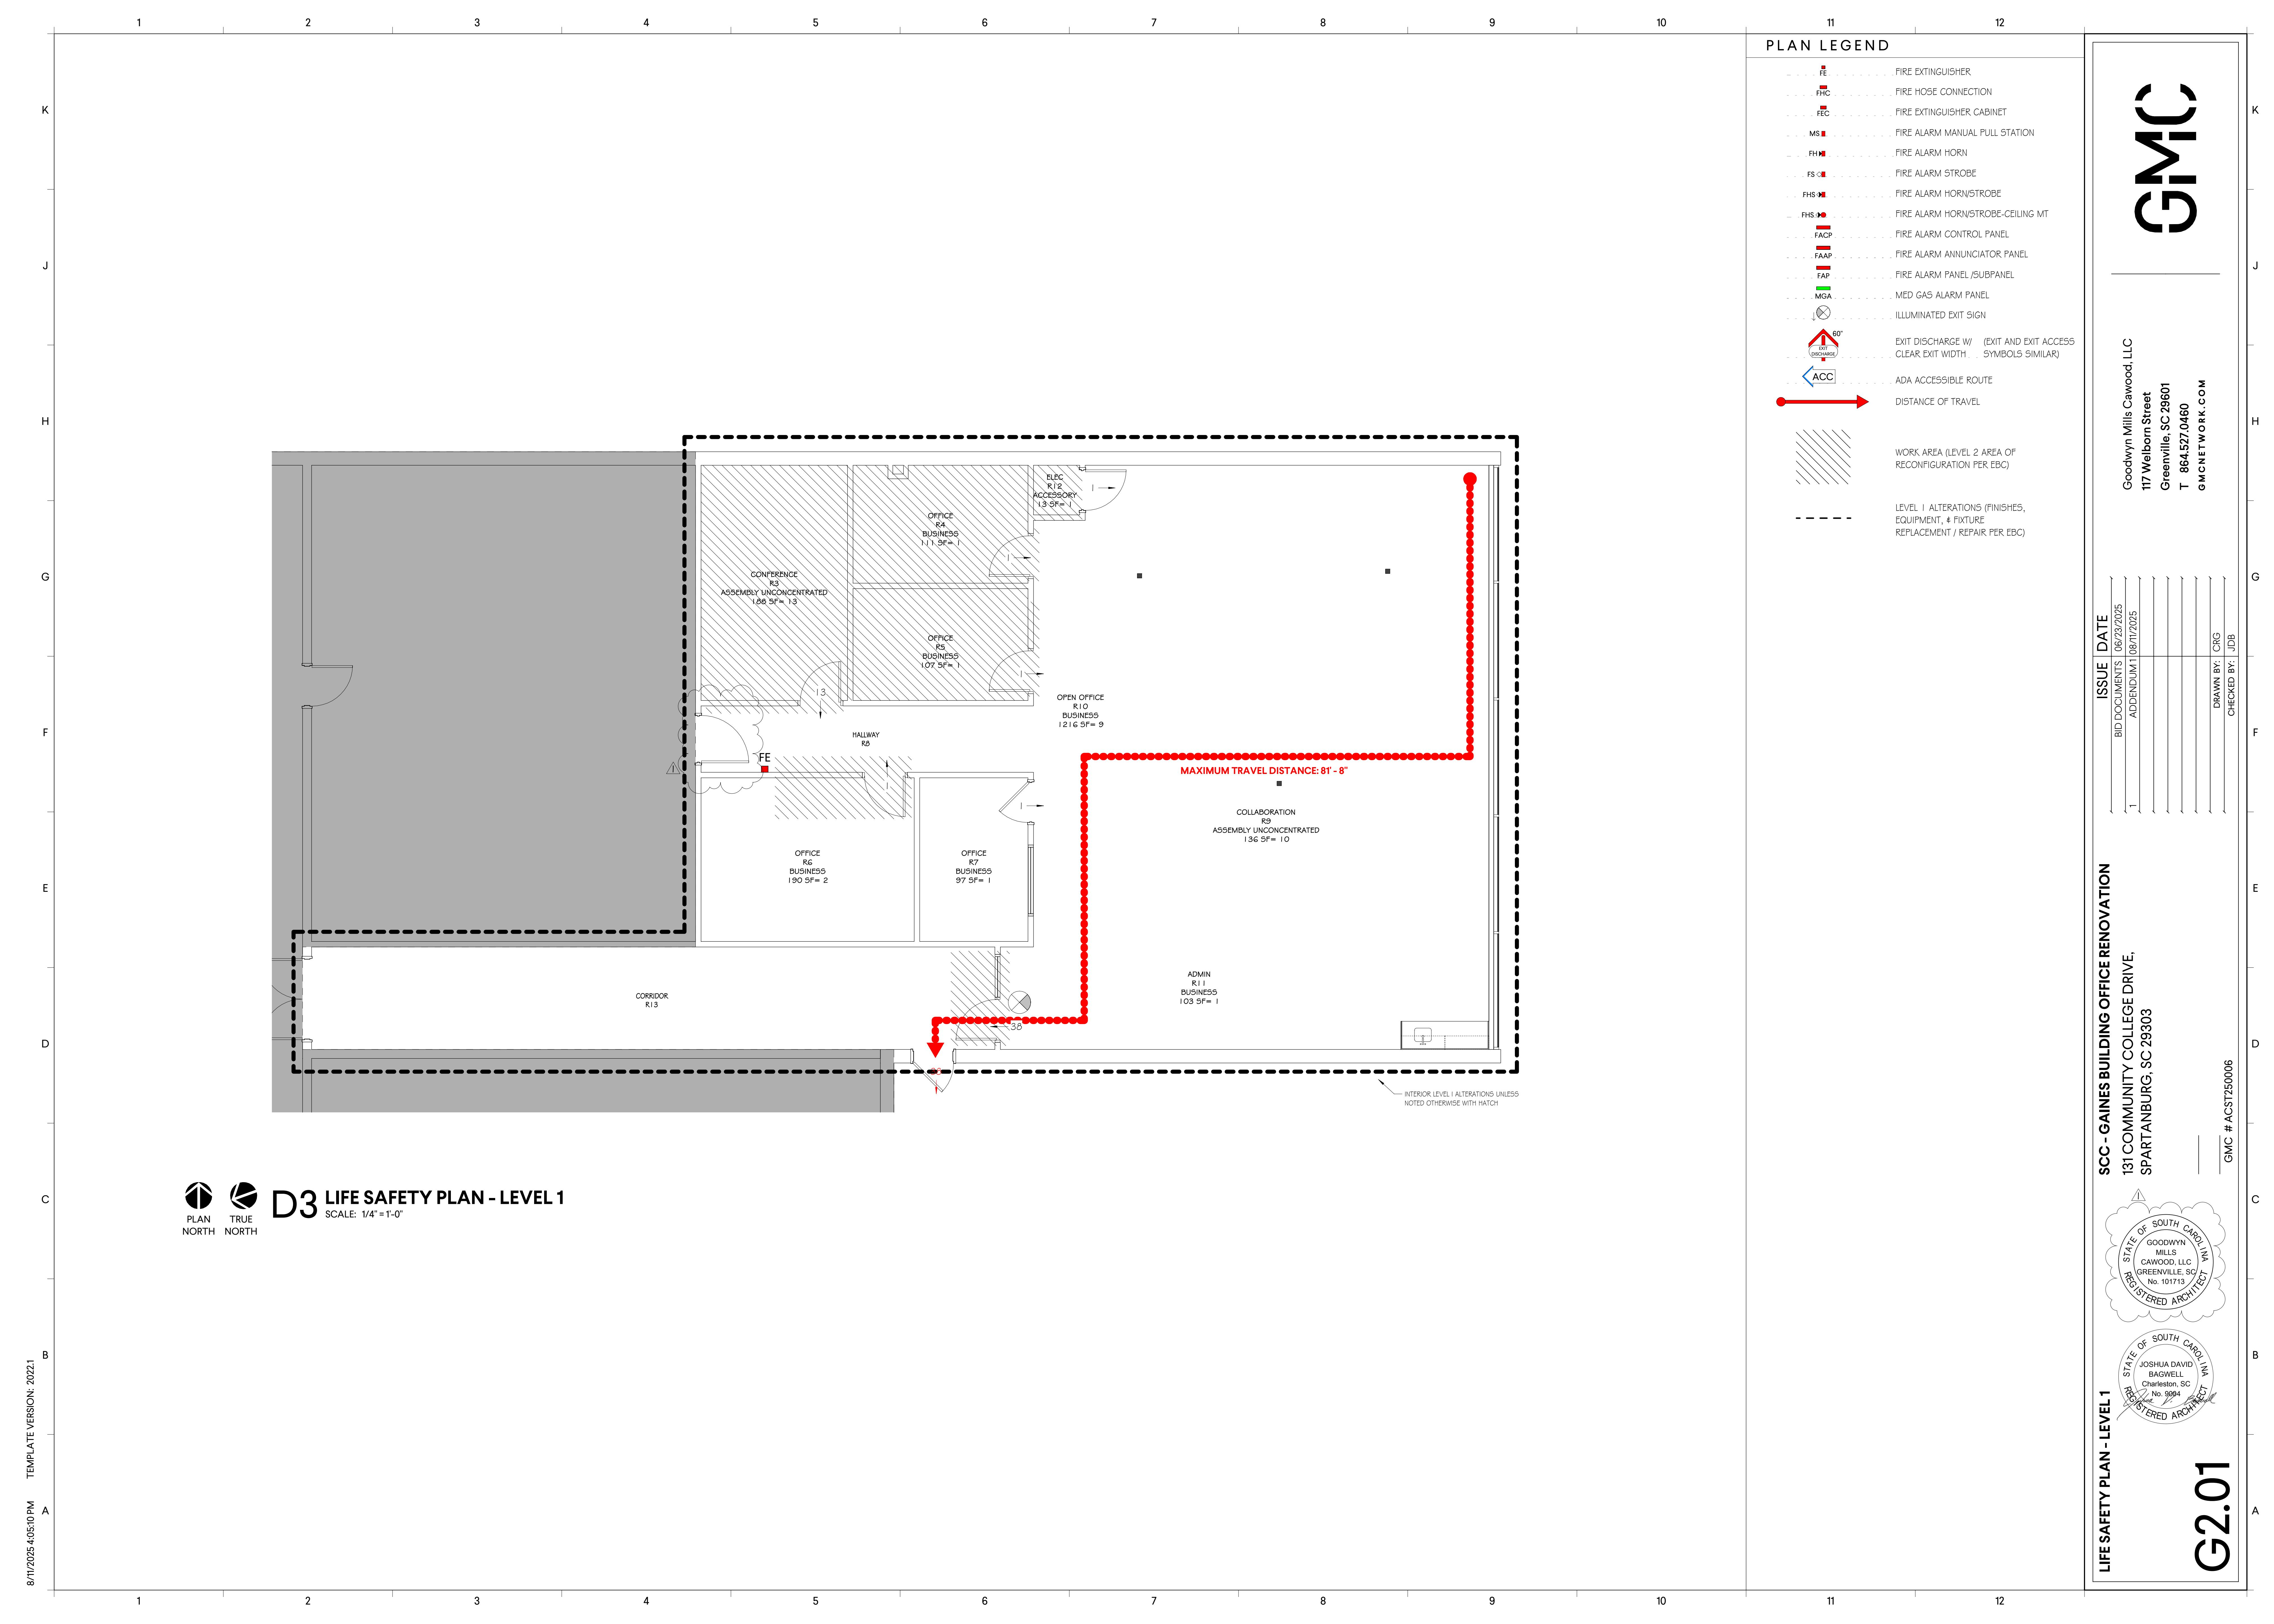
SCC - GAINES BUILDING OFFICE RENOVATION
131 COMMUNITY COLLEGE DRIVE,
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GMC # ACST250006





GENERAL INFORMATION
G1.03
STATE OF SOUTH CAROLINA
GOODWYN MILLS CAWOOD, LLC
GREENVILLE, SC
No. 101713
JOSHUA DAVID BAGWELL
Charleston, SC
No. 9004
REGISTERED ARCHITECT

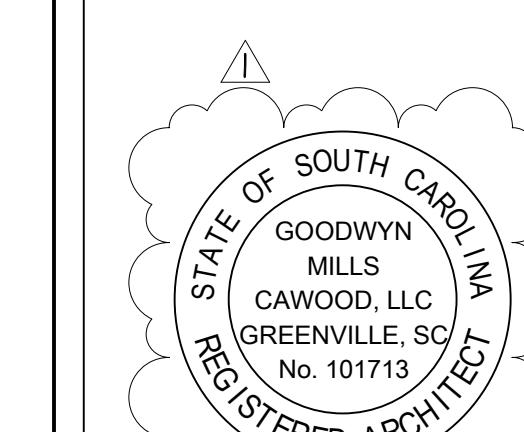




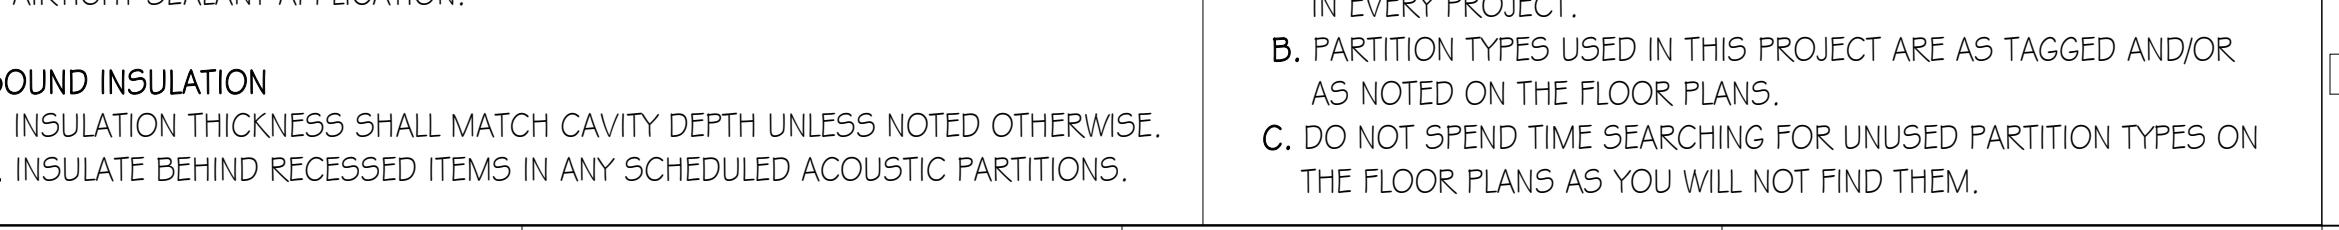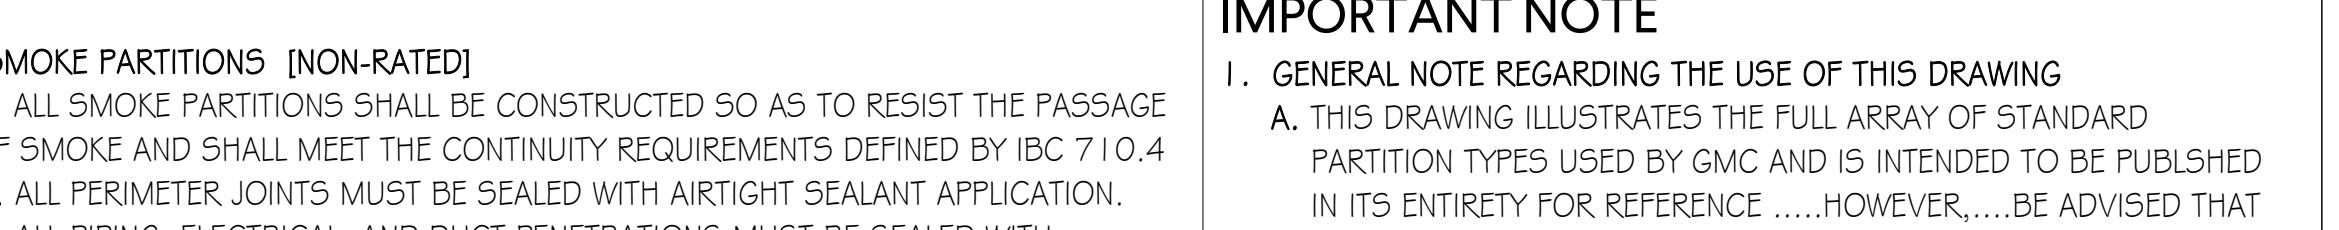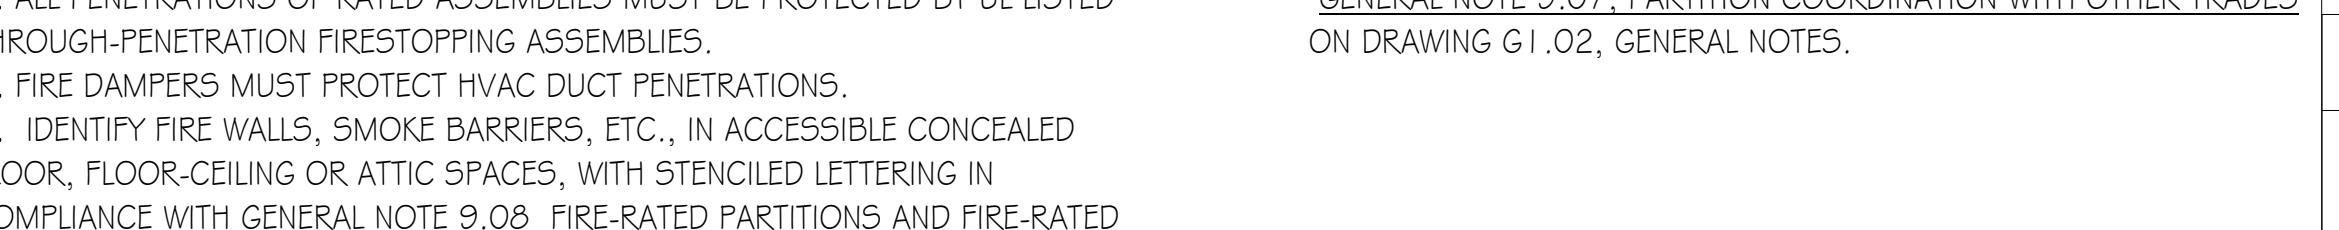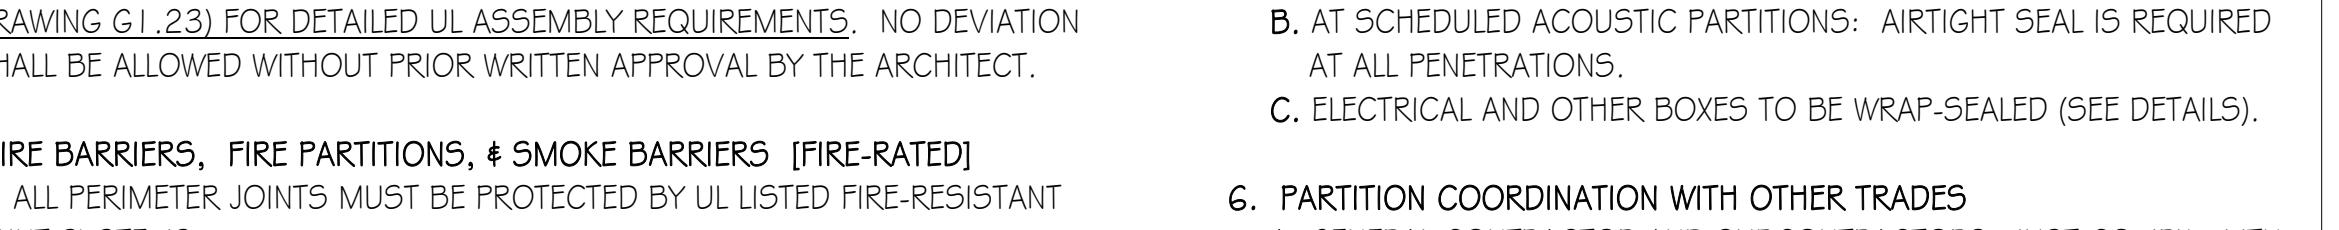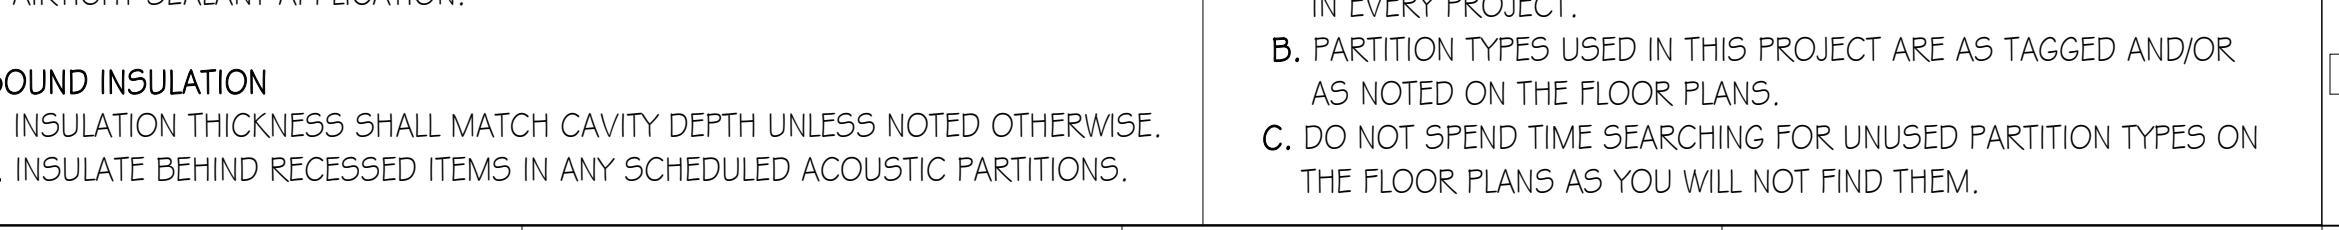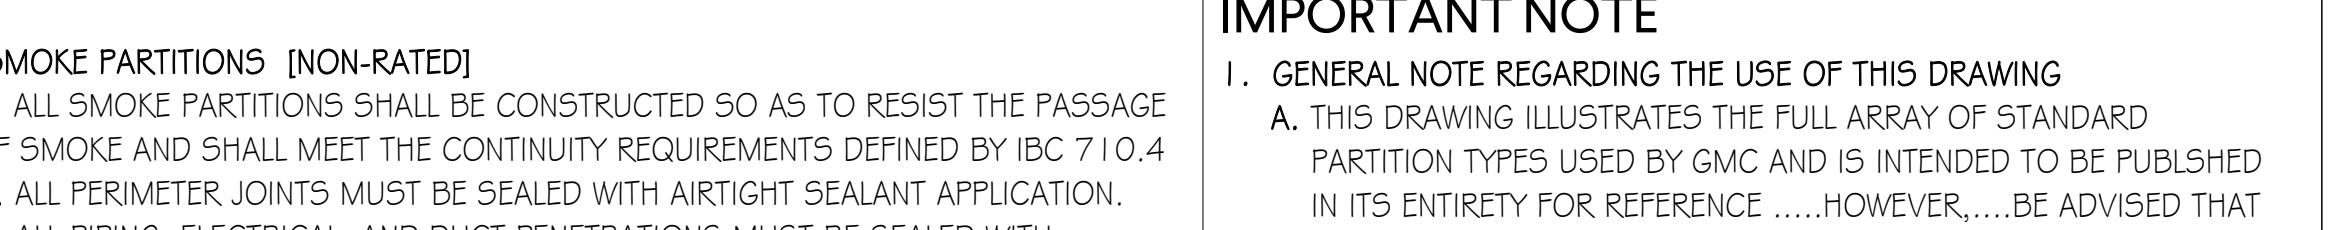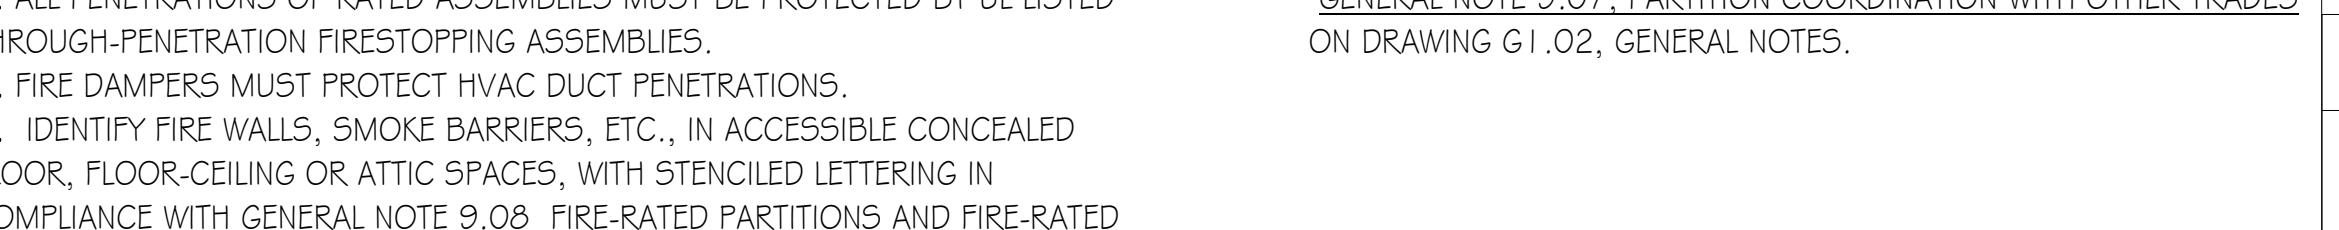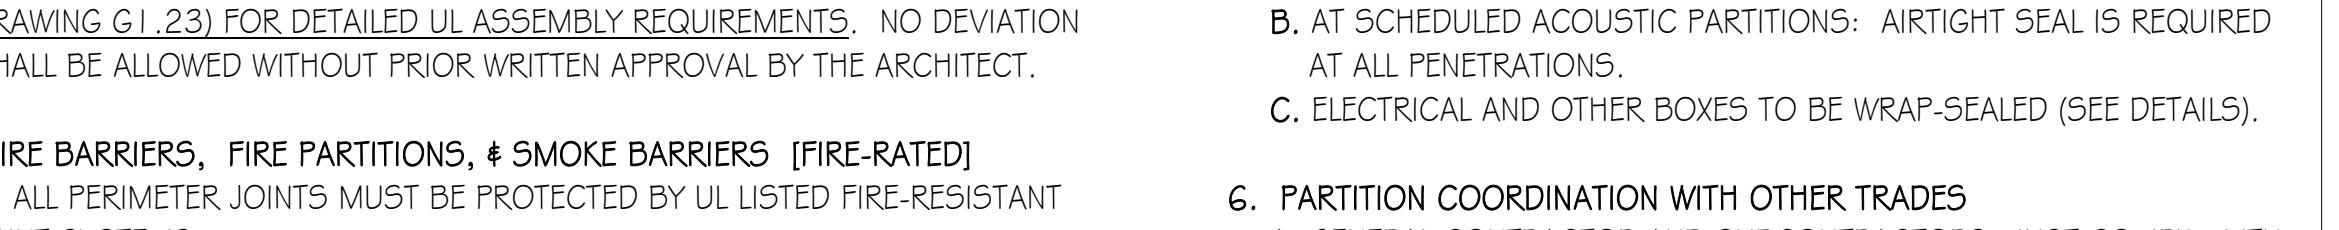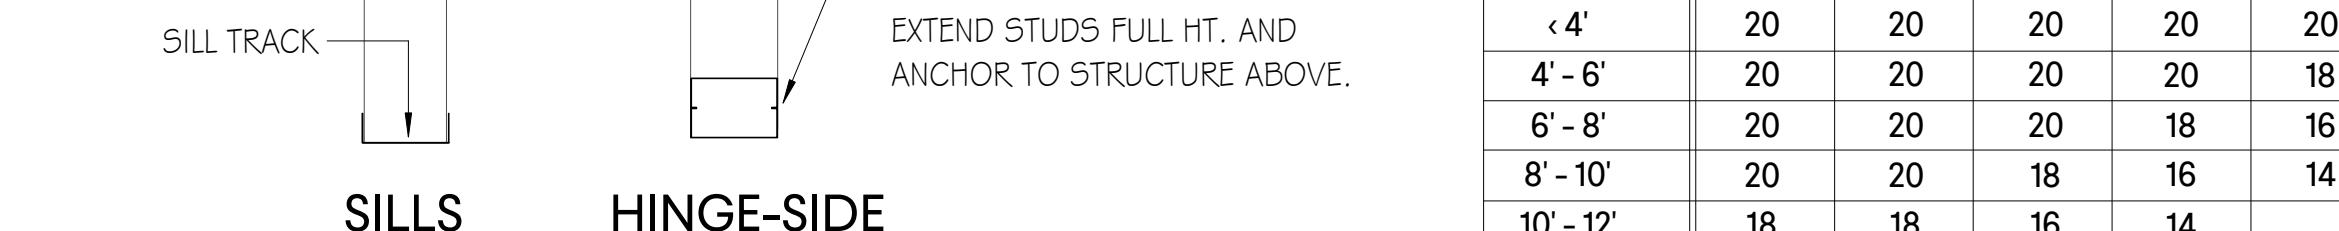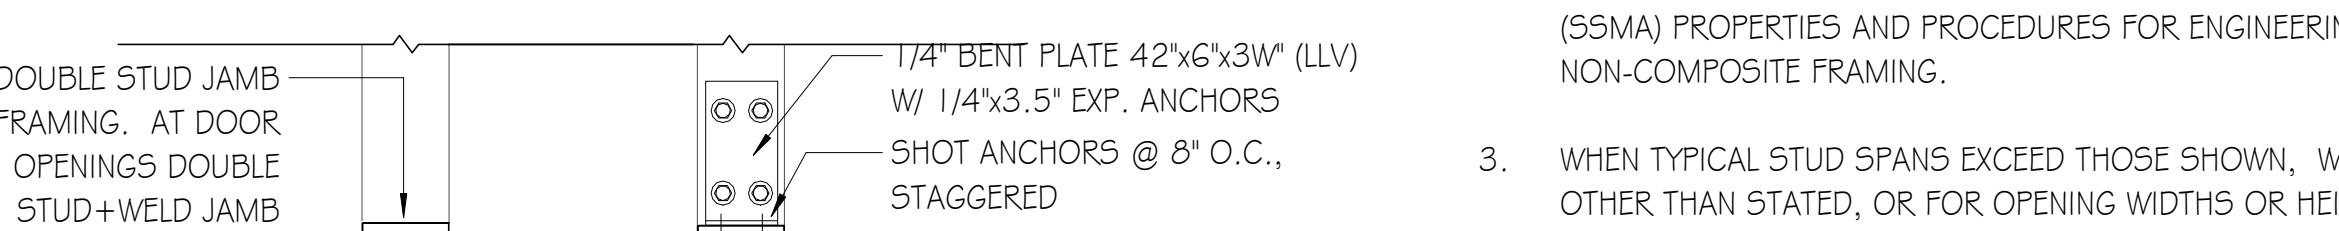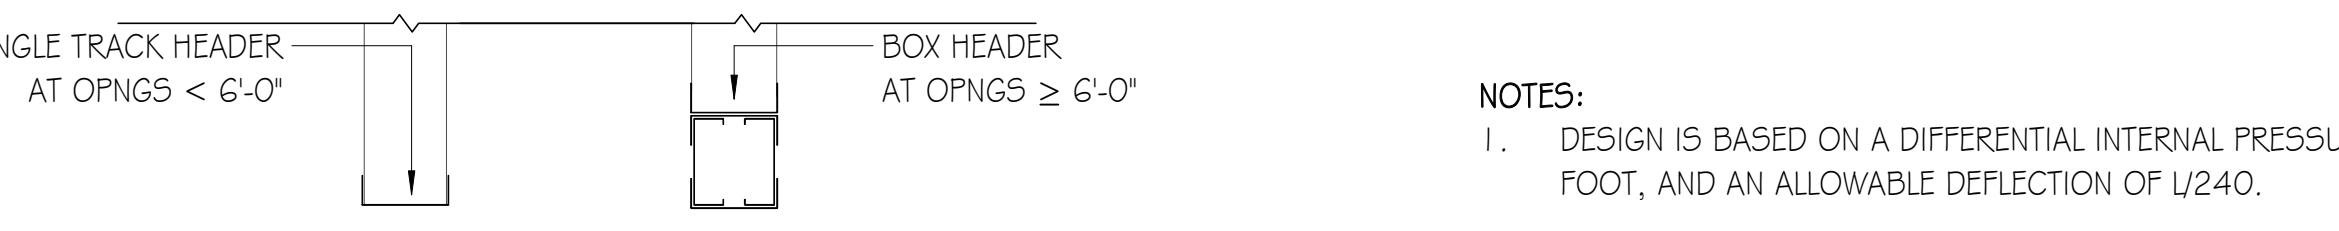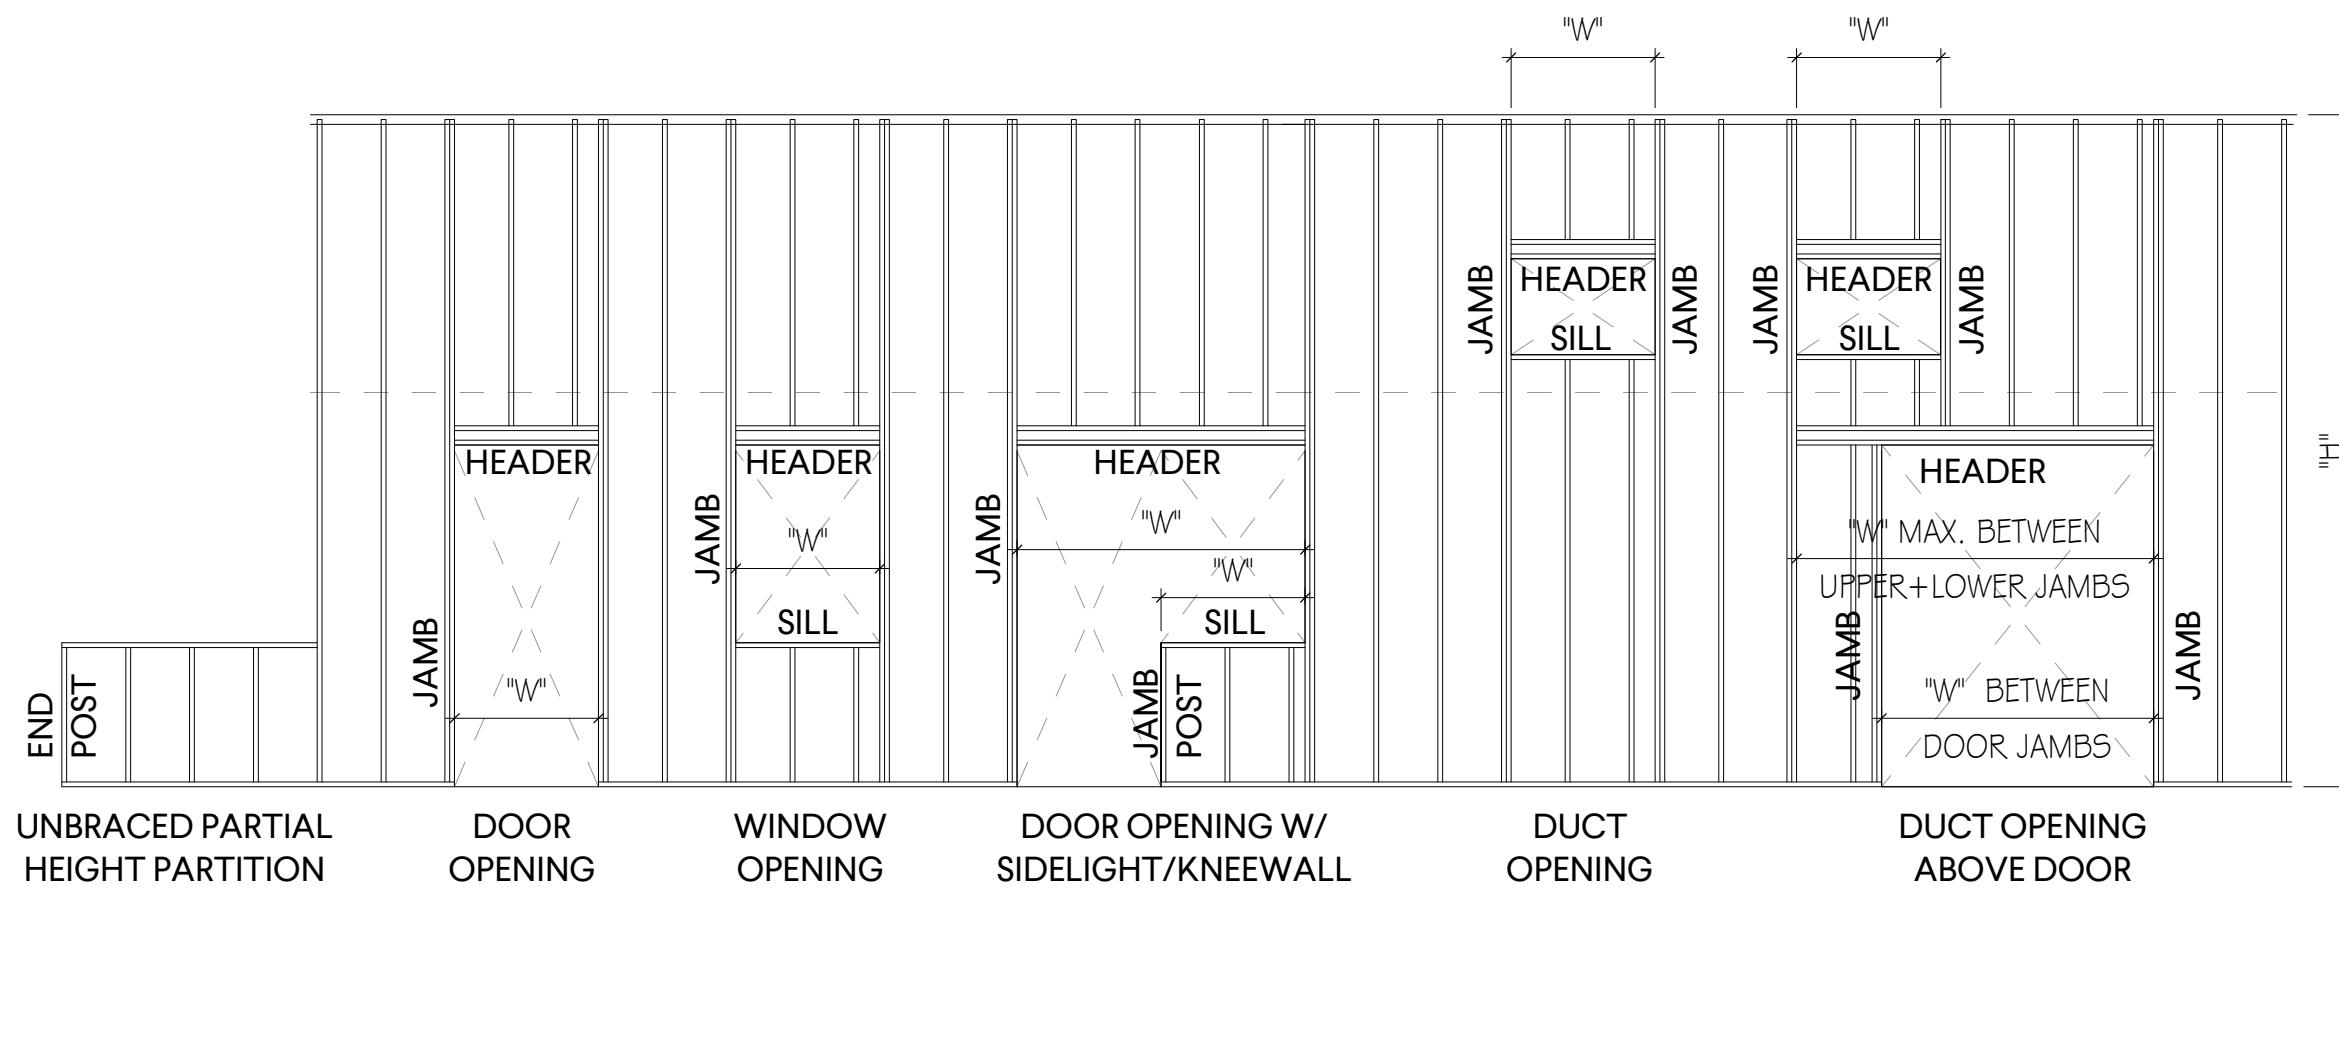

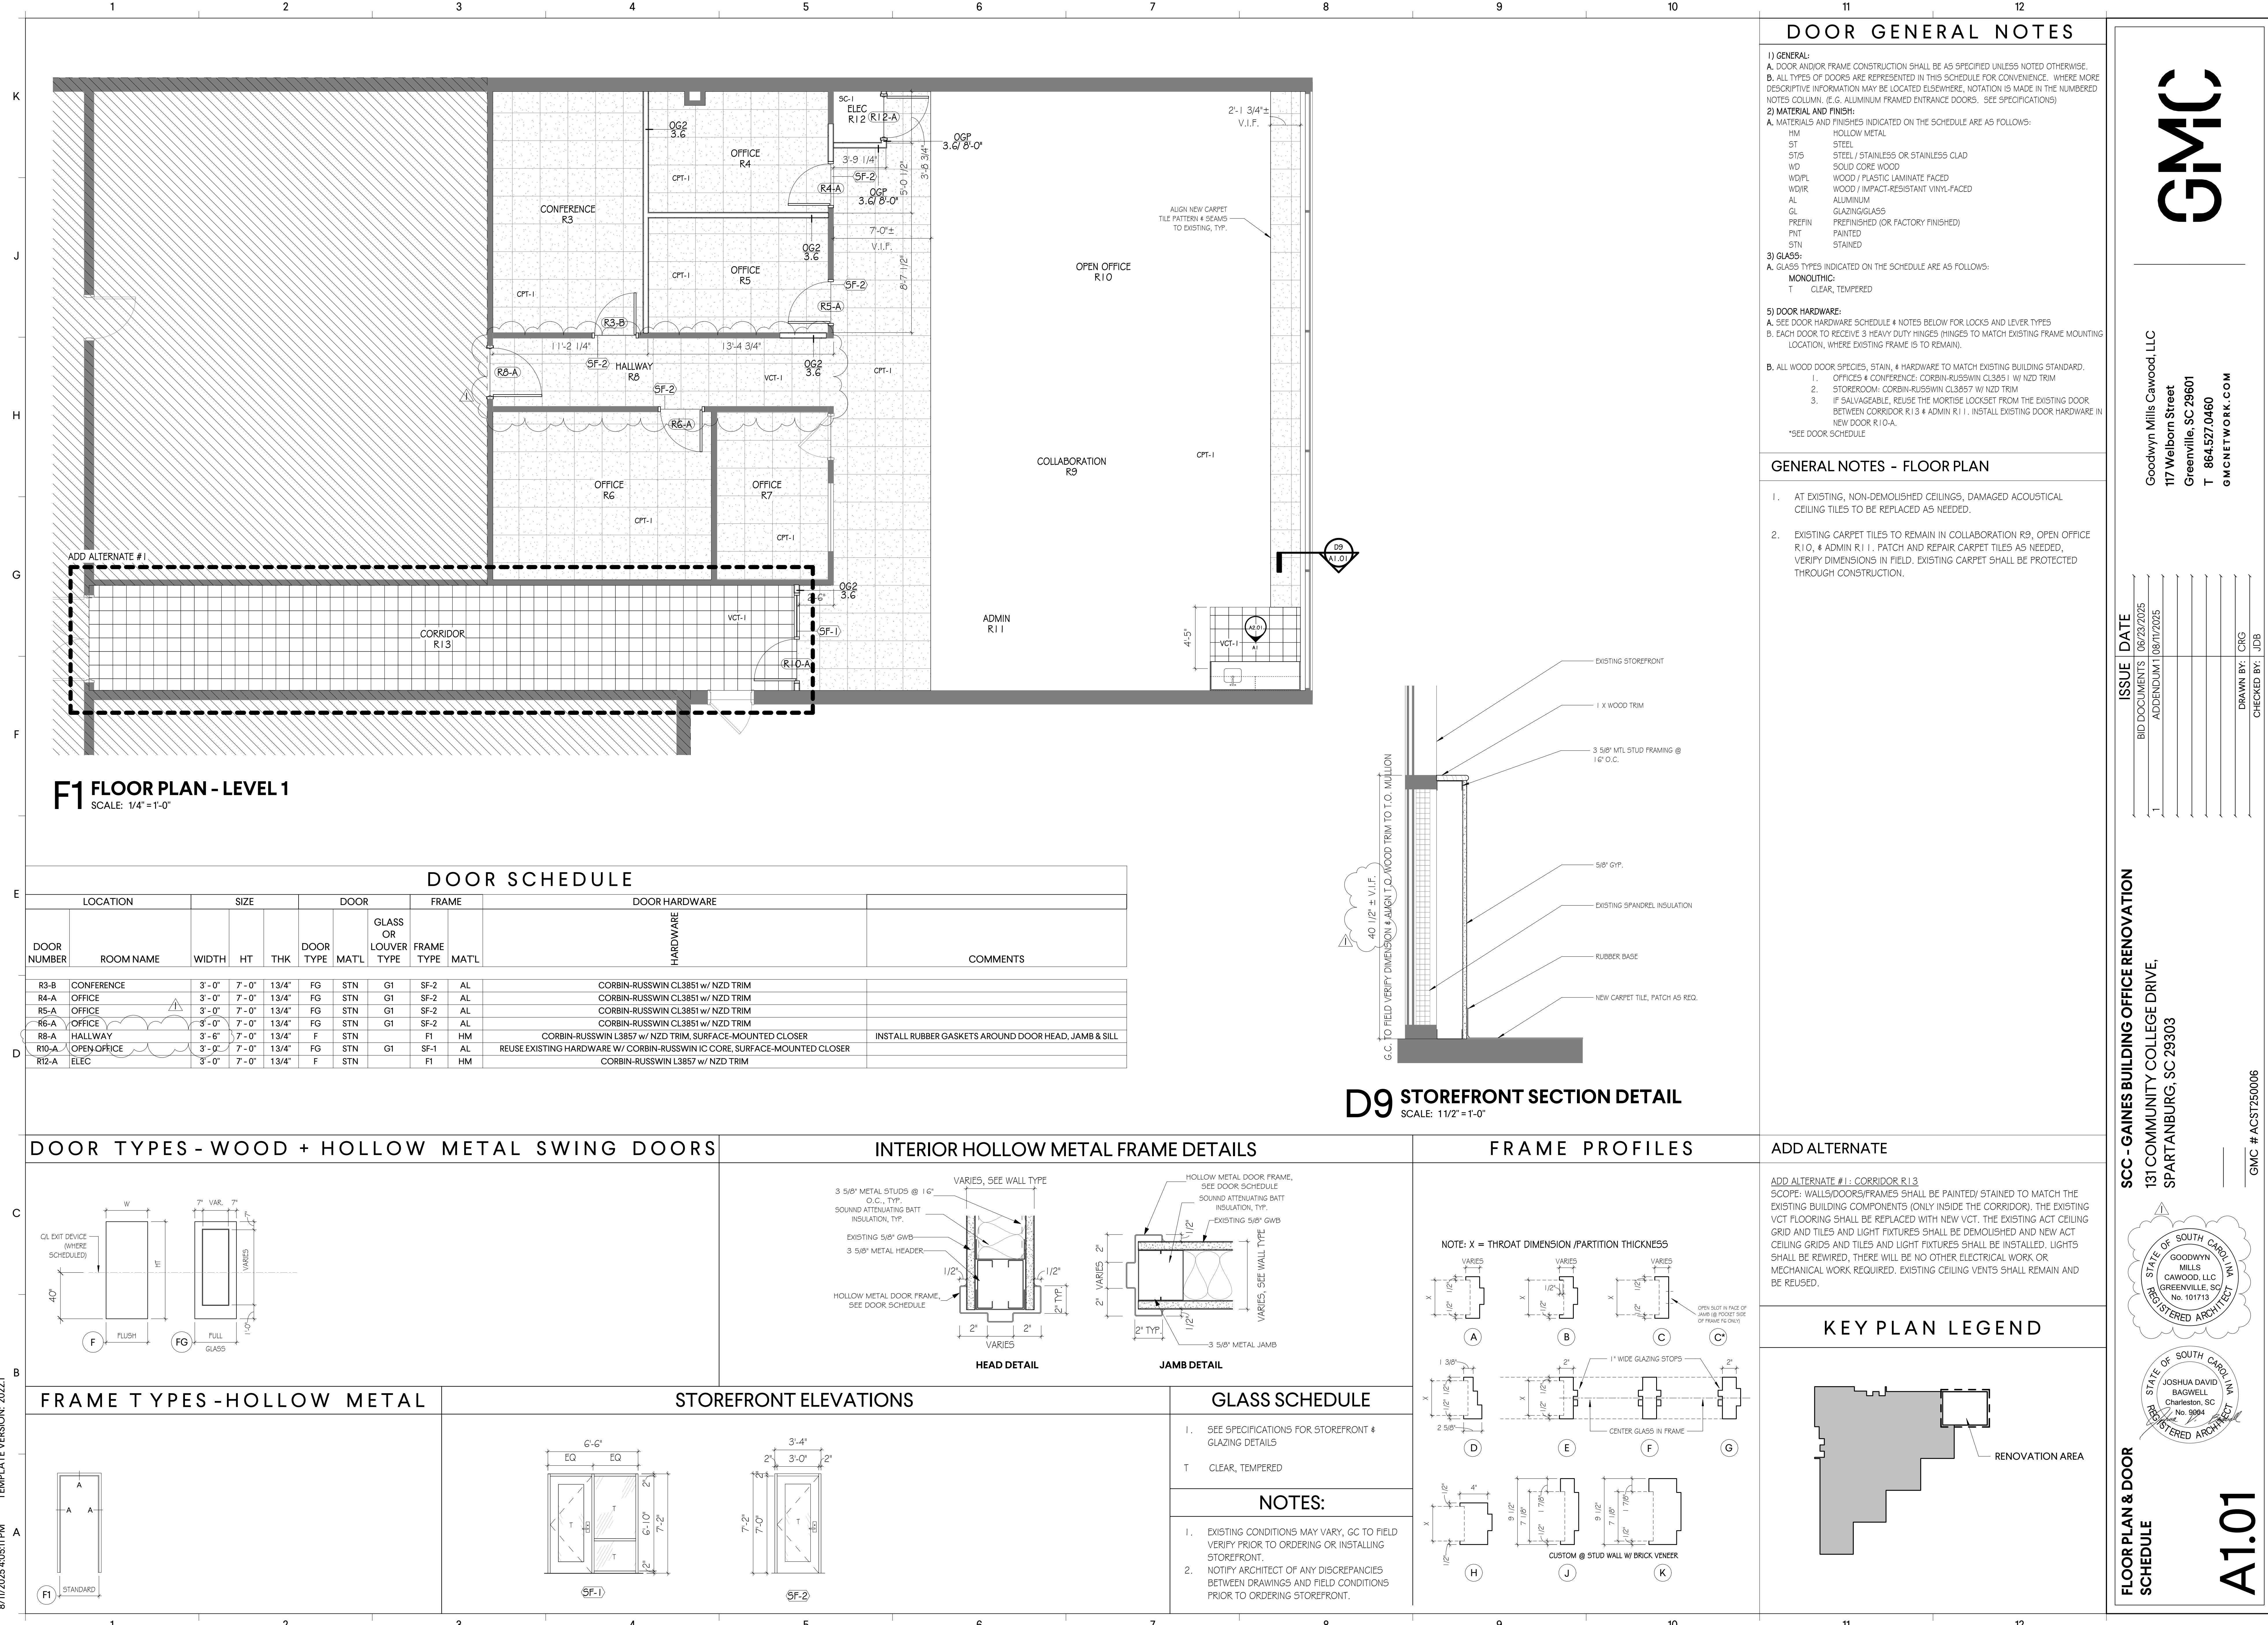


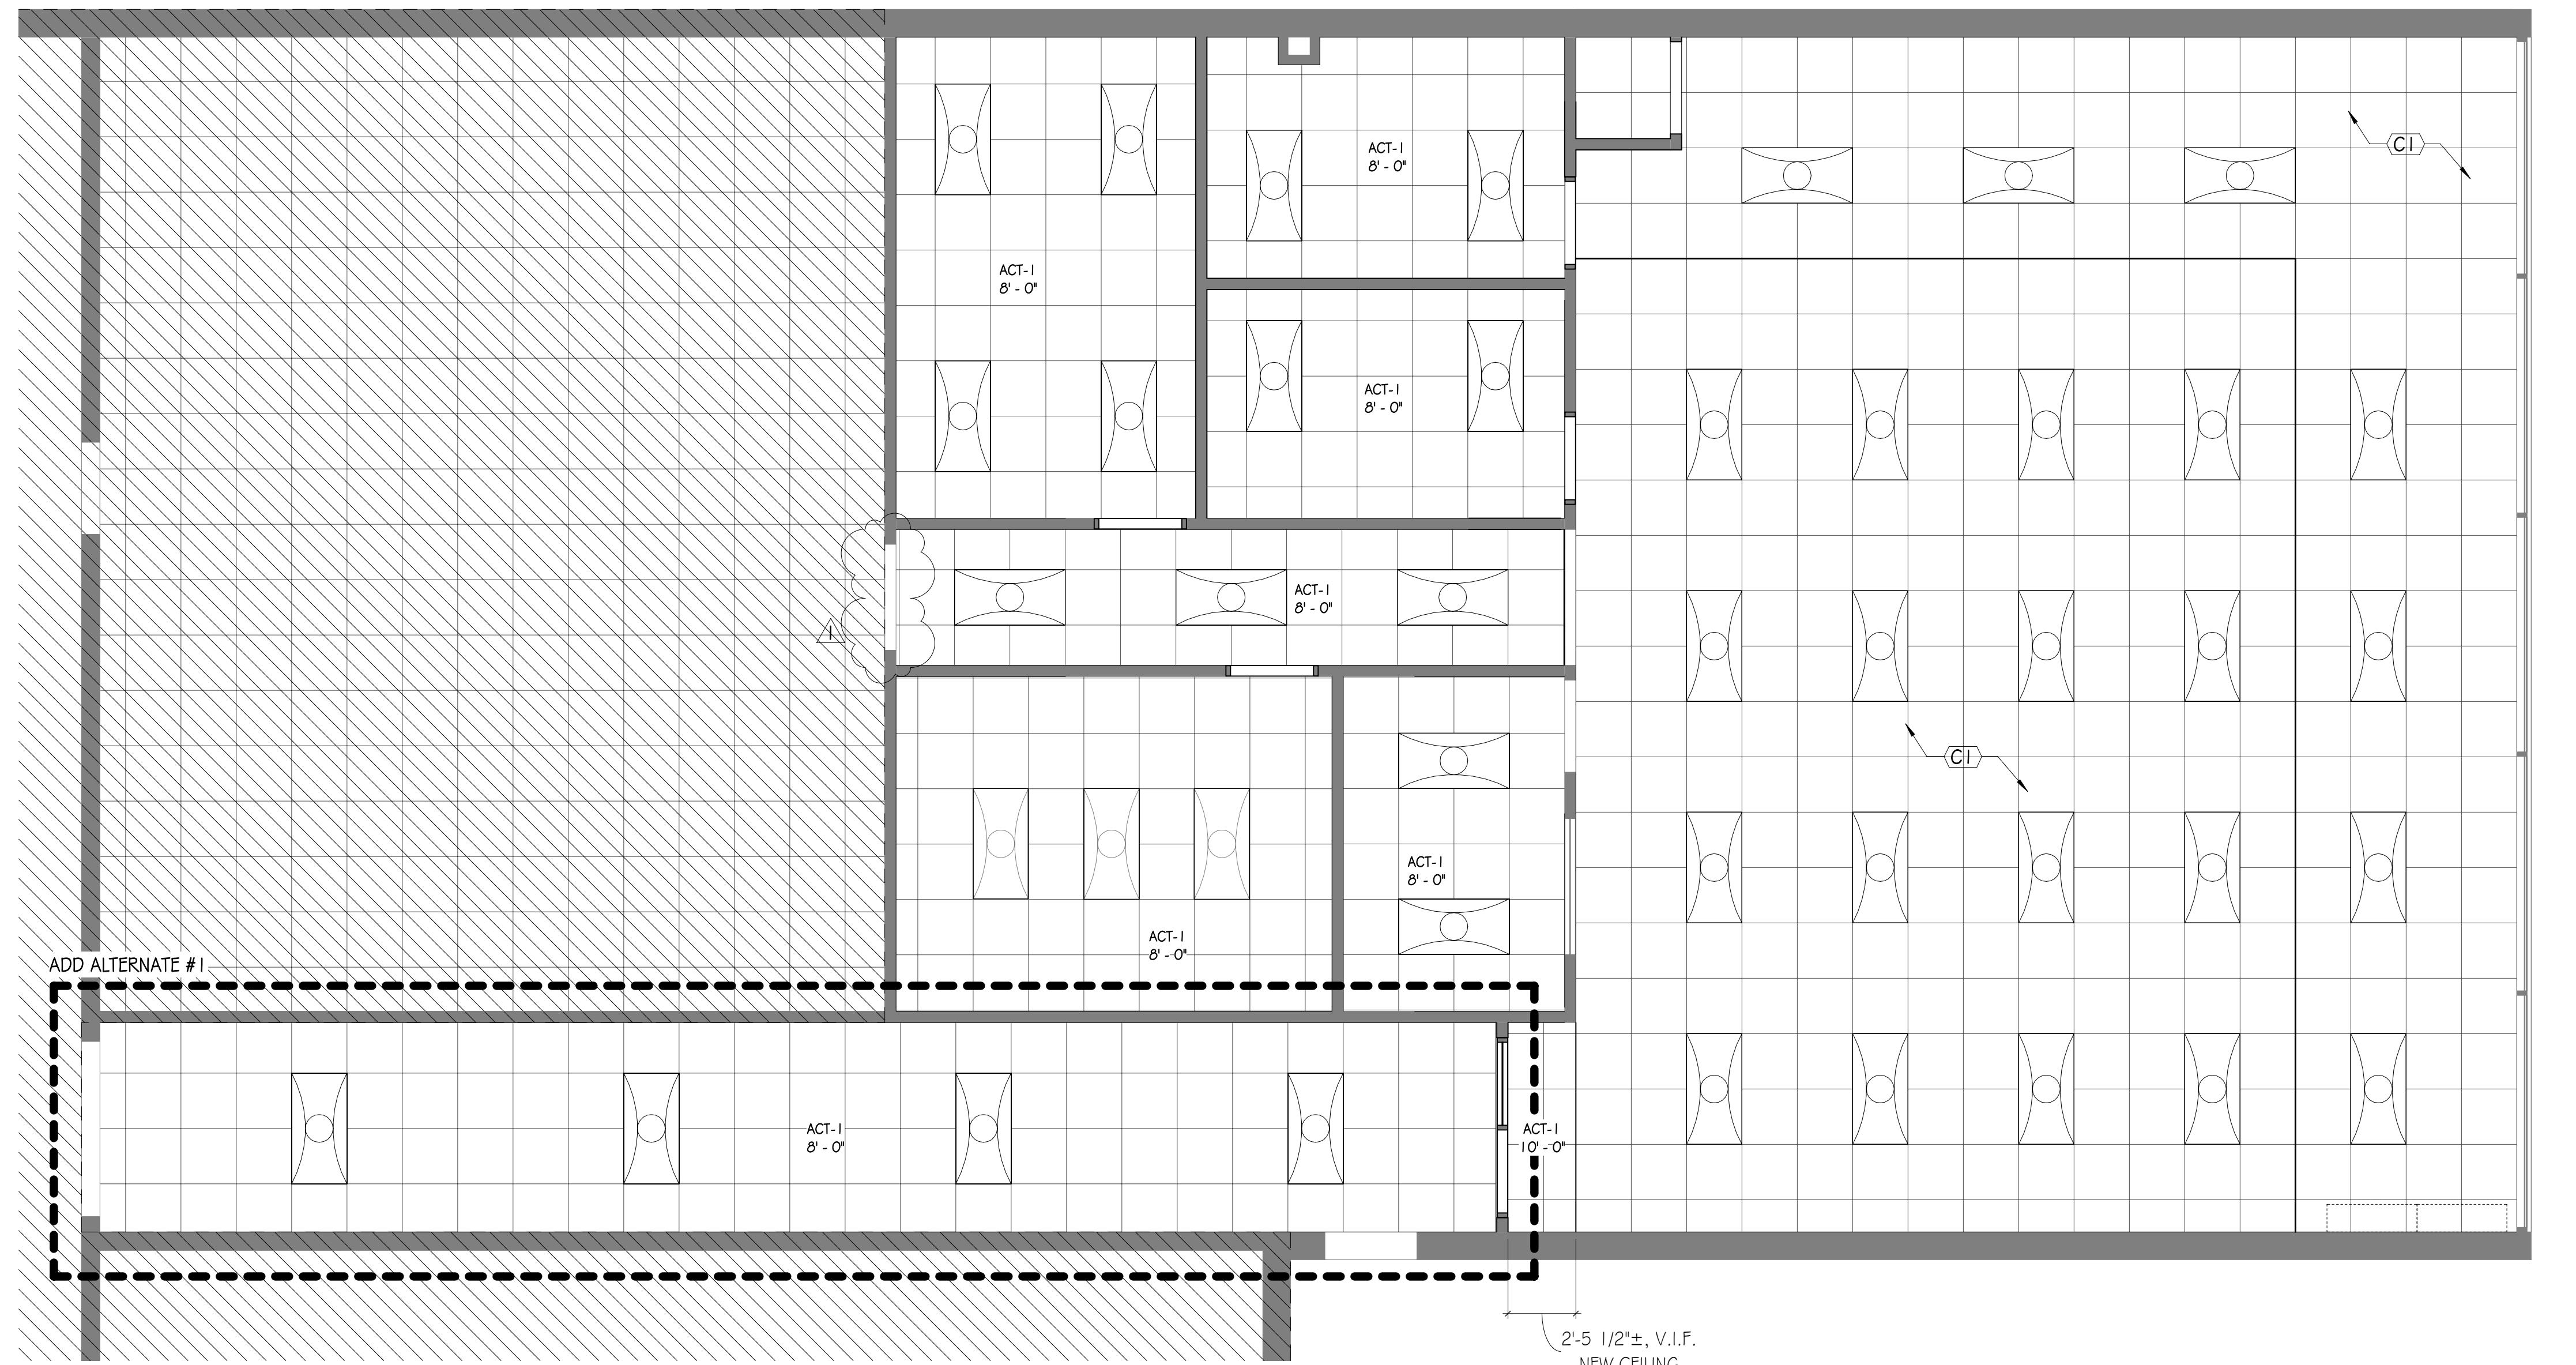


E1 REFLECTED CEILING PLAN - LEVEL 1
SCALE: 1/4" = 1'-0"

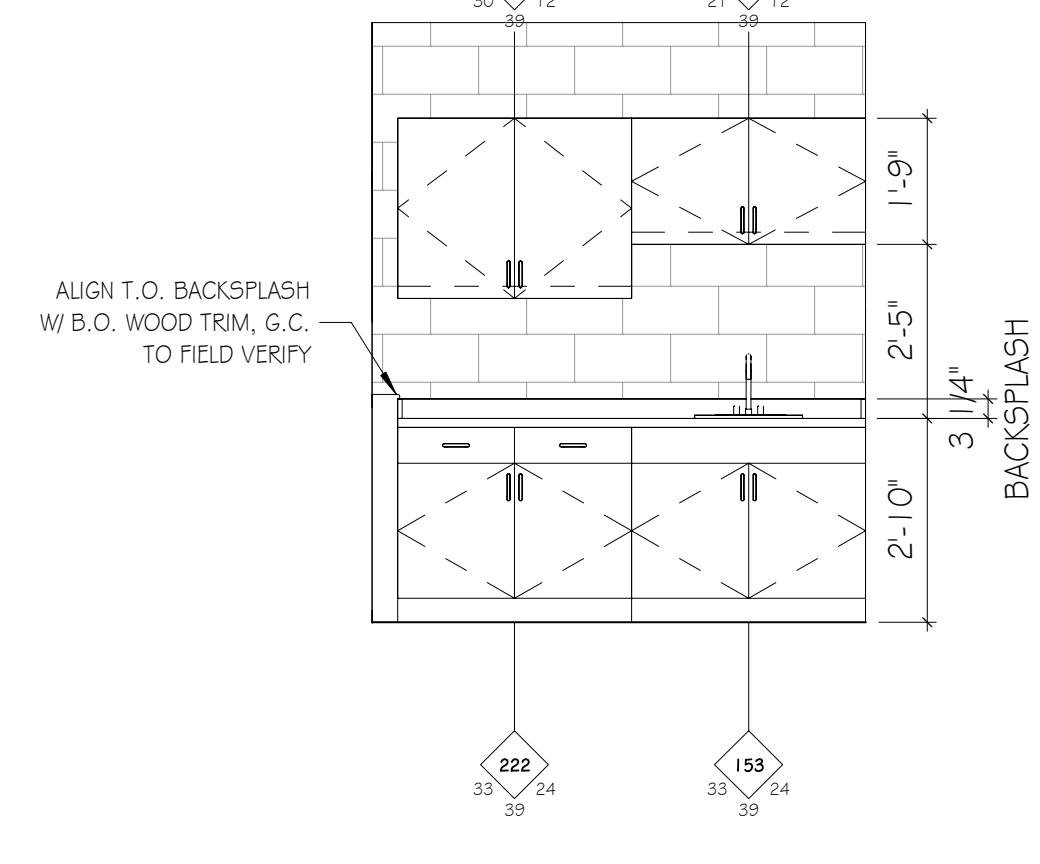


A1 ELEV - OPEN OFFICE R10 SOUTH
SCALE: 3/8" = 1'-0"

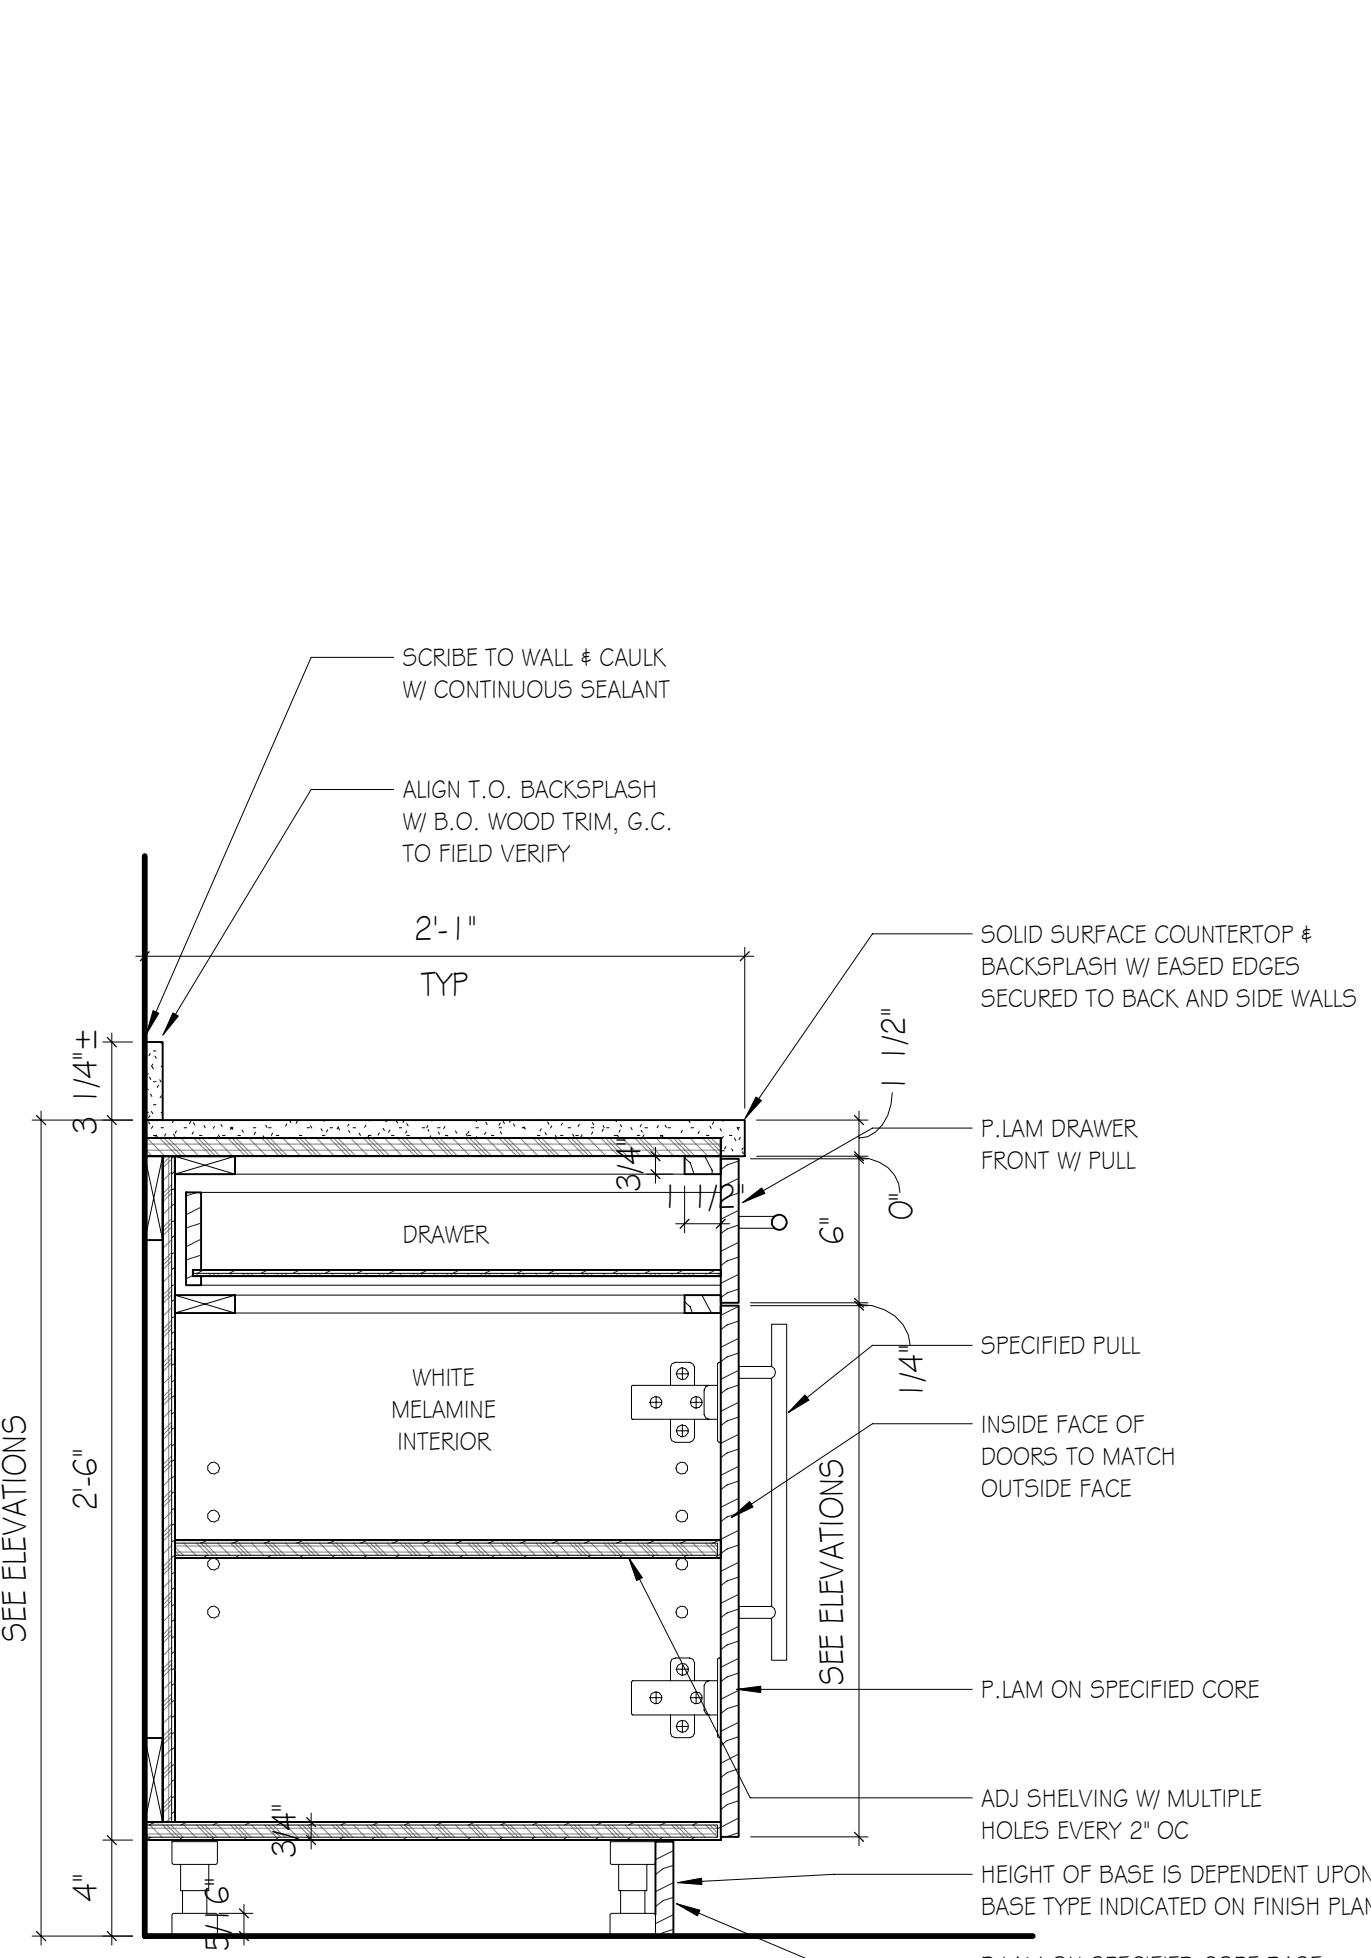

A5 (M4) TYP. DR & DWR BASE CABINET
SCALE: 11/2" = 1'-0"

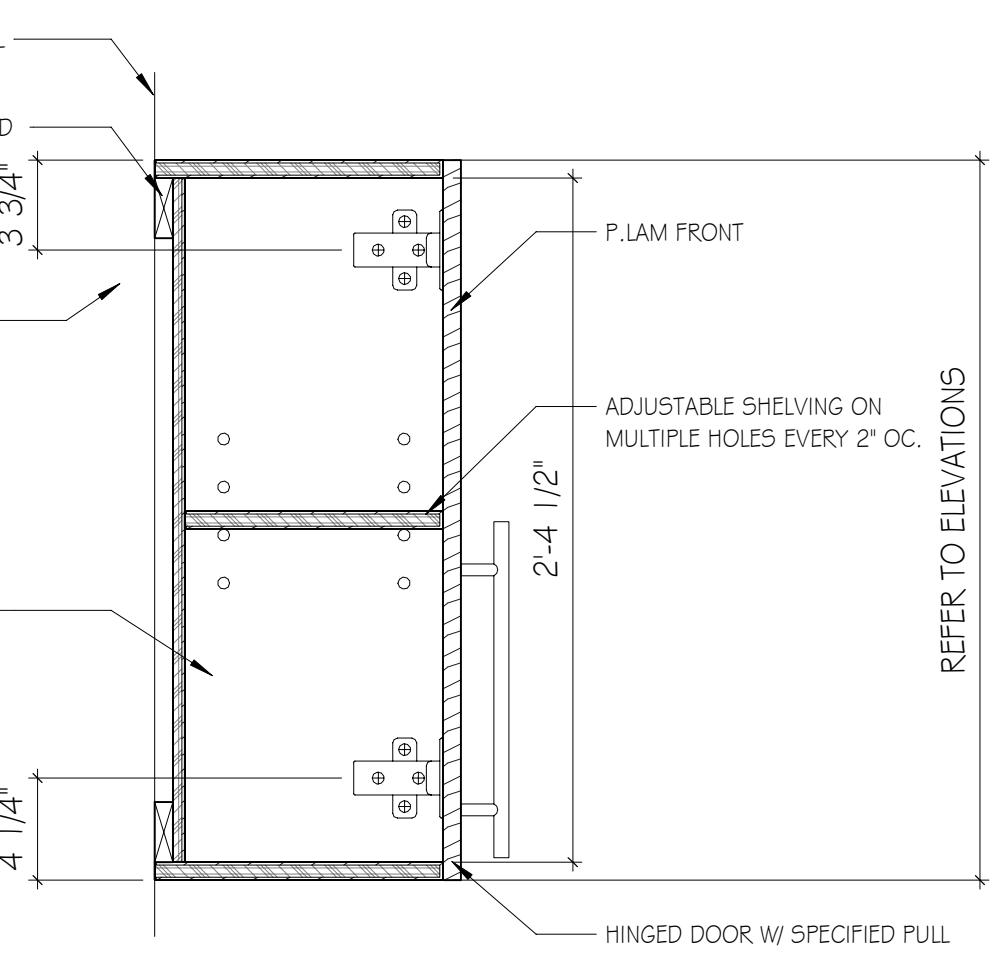


D8 (M9) TYP. UPPER CABINET
SCALE: 11/2" = 1'-0"

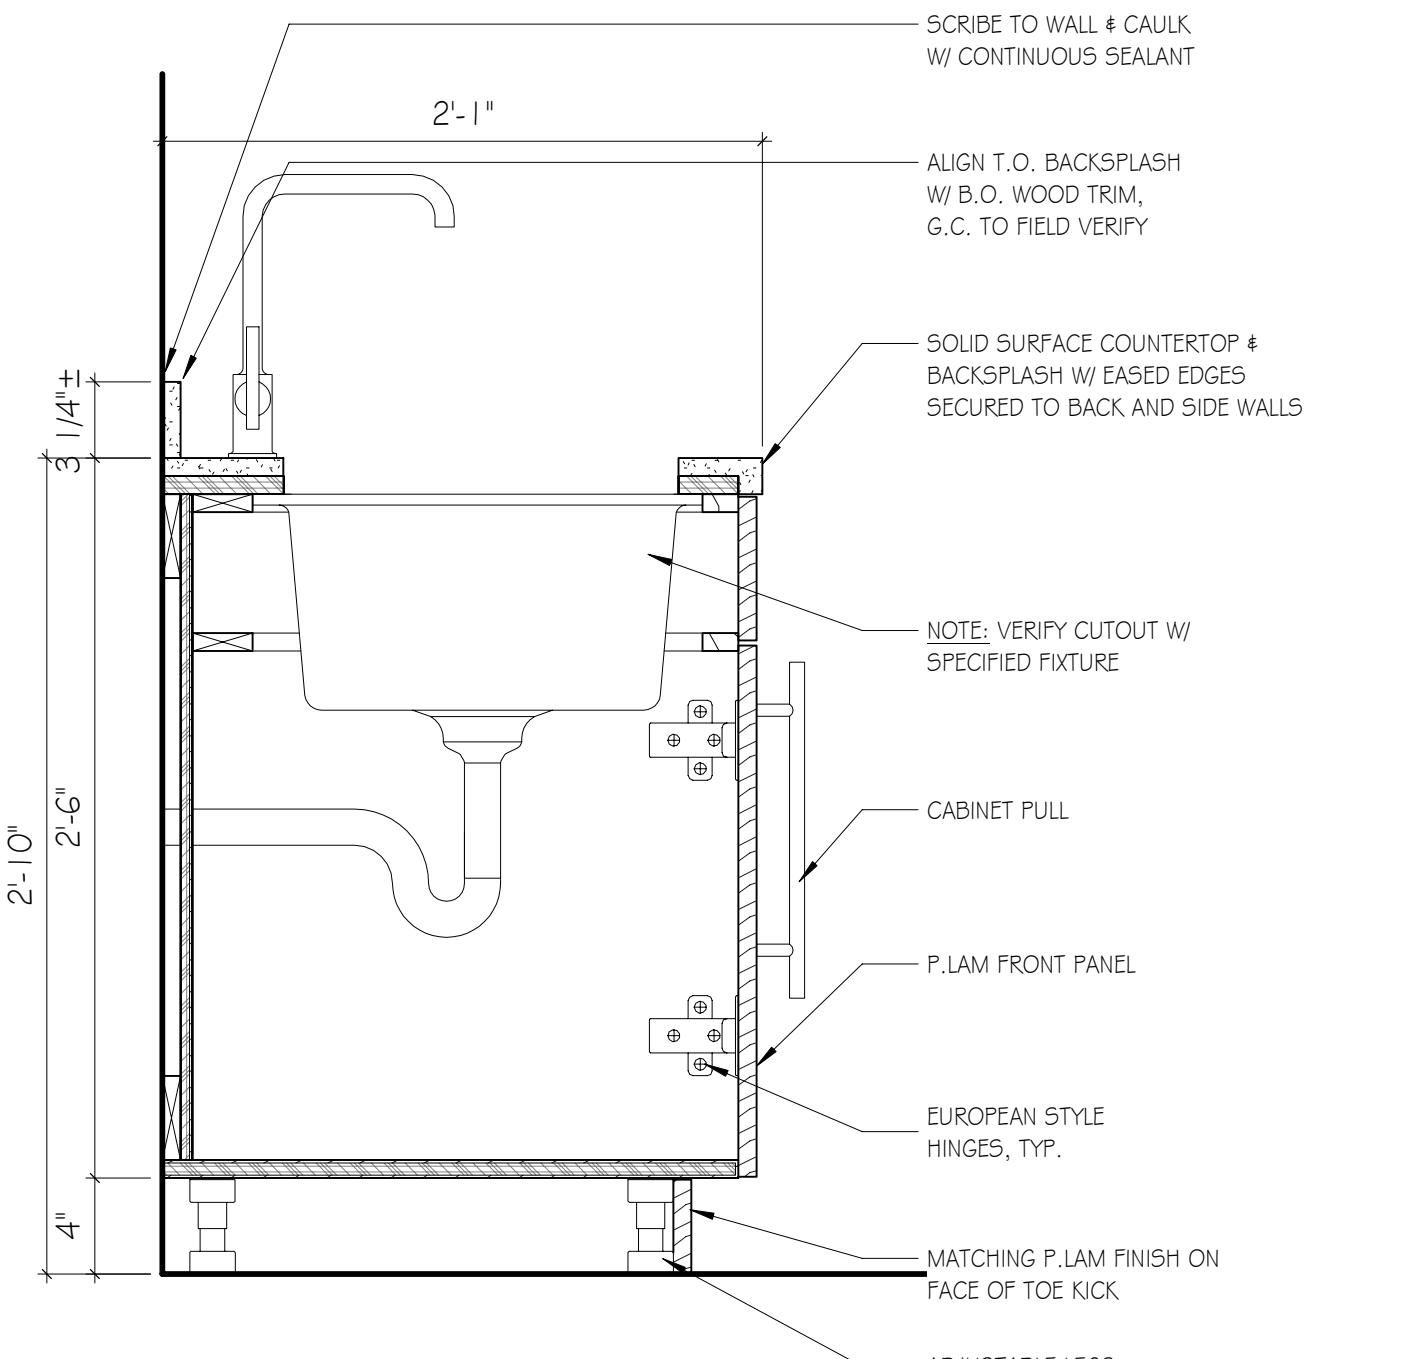

A8 (M6) TYP. BASE SINK CABINET
SCALE: 11/2" = 1'-0"

KEY NOTES - CEILING PLAN
KEY
C1 ACoustical ceiling grid to remain, replace damaged acoustical ceiling tiles as needed.

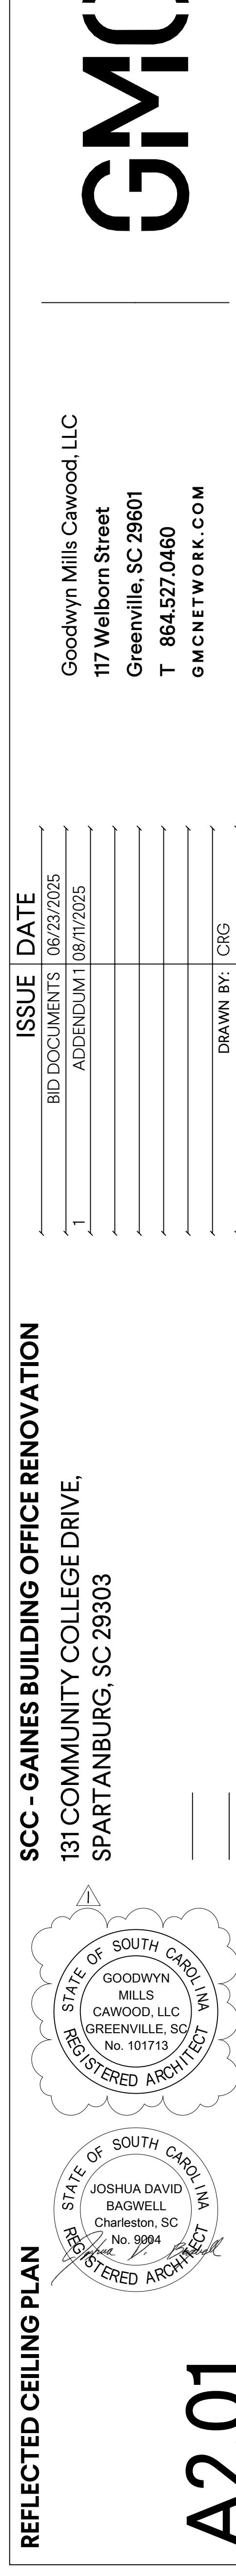

SCC - GAINES BUILDING OFFICE RENOVATION
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ISSUE DATE
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1 DRAWN BY: CRG
CHECKED BY: JDB

GENERAL NOTES - REFLECTED CEILING PLAN
1. CEILING HEIGHTS SHALL BE AS NOTED ON REFLECTED CEILING PLANS.
2. NEW CEILINGS WILL BE TAGGED WITH TYPE AND HEIGHT.
3. EXISTING CEILINGS TO REMAIN WILL NOT BE TAGGED.
4. WHEREVER POSSIBLE NO CEILING TILE SHOULD BE LESS THAN 6" IN ANY DIRECTION.
5. SEE ELECTRICAL FOR ALL LIGHT FIXTURE TYPES AND SIZES.
6. SEE MECHANICAL FOR ALL DIFFUSER TYPES AND SIZES.
7. COORDINATE LOCATIONS OF ALL LIGHTS, DIFFUSERS, AND DEVICES BETWEEN THIS RCP AND MECHANICAL, FIRE PROTECTION, AND ELECTRICAL.
8. NOTIFY ARCHITECT OF ANY DISCREPANCIES FOUND BEFORE PROCEEDING.
9. WHERE EXIT SIGNS ARE LOCATED ABOVE DOORWAYS, CENTER FIXTURE OVER DOOR BUT MAINTAIN MINIMUM OVERHEAD CLEARANCE.

REFLECTED CEILING PLAN

STATE OF SOUTH CAROLINA
GOODWYN MILLS
GREENVILLE, SC
No. 101713
REGISTERED ARCHITECT

STATE OF SOUTH CAROLINA
JOSHUA DAVID BAGWELL
Charleston, SC
No. 9004
REGISTERED ARCHITECT

A2.01

1	2	3	4	5	6	7	8	9	10	11	12				
FINISH NOTES															
FLOORS:		WALLS:		MISC:		RCP NOTES:			FINISH LEGEND						
<ul style="list-style-type: none"> REFER TO FLOOR FINISH PLANS FOR FLOOR PATTERN. CONTRACTOR MUST NOTIFY INTERIOR DESIGNER BEFORE INSTALLATION OF FLOORING TO REVIEW DESIGN INTENT OF FLOOR PATTERN PLAN. ALL FLOORING TRANSITIONS INCLUDING TRANSITIONS TO SIMILAR MATERIAL OR REDUCER STRIPS AND OTHER THRESHOLDS SHALL BE LOCATED AT THE CENTERLINE OF DOOR WHEN IN CLOSED POSITION. COLORS SHALL BE SELECTED DURING SUBMITTAL REVIEW. REFER TO DETAILS FOR TRANSITIONS BETWEEN FLOORING MATERIALS. CONTRACTOR TO PROVIDE TRANSITION SIZES APPROPRIATE FOR THICKNESS AVOID ALL FLOORING MATERIAL SLIVER CUTS LESS THAN 4" WIDE @ WALL PERIMETERS & MATERIAL TRANSITIONS. CONTACT DESIGNER IF JOBSITE CONDITIONS DIFFER. INSTALL FLOORING CONTINUOUS UNDER ALL CASEWORK, MILLWORK, EQUIPMENT, & FURNITURE ALIGN VERTICAL GROUT JOINTS IN TILE BASE WITH THOSE IN THE FLOOR TILE UNLESS NOTED OTHERWISE 		<ul style="list-style-type: none"> REFER TO FINISH PLANS & ELEVATIONS FOR LOCATION OF ACCENT PAINT COLORS ALL HOLLOW METAL DOOR & WINDOW FRAMES TO BE PAINTED (PNT-2) UNLESS OTHERWISE NOTED ALL ACCESS PANELS AND MISCELLANEOUS METAL (RETURN AND AIR SUPPLY GRILLES, EXPANSION JOINTS, ETC.) LOCATED ON WALL SURFACES OR CEILING SURFACES TO BE PAINTED WALL OR CEILING COLOR U.N.O. WALL BASE TO BE INSTALLED ON ALL WALLS, MILLWORK, AND CASEWORK U.N.O. 		<ul style="list-style-type: none"> DO NOT PAINT DOOR LABELS AT RATED DOORS OR FRAMES. PROVIDE BLOCKING AS REQUIRED AT ALL TELEVISION LOCATIONS - COORDINATE WITH OWNER'S EQUIPMENT CAULK ALL DOOR FRAMES, MILLWORK, AND VIEW WINDOW FRAMES AFTER WALLCOVERING INSTALLATION IS COMPLETE. COLOR OF CAULK TO MATCH ADJACENT FINISH. GC TO PROVIDE SPECIFIED EXPANSION JOINT COVER AT ALL EXPOSED FINISH FLOOR, CEILING, AND WALL LOCATIONS WALL BASE TO BE INSTALLED ON ALL WALLS, MILLWORK, AND CASEWORK U.N.O. MARKER BOARDS HEIGHTS TO BE (3'-0" A.F.F.) TO THE BOTTOM OF WRITING SURFACE. GC TO COORDINATE WALL BLOCKING AS REQ'D. ALL PARTIES RESPONSIBLE FOR DELIVERING FINISHES TO THE SITE SHALL CHECK AVAILABILITY OF QUANTITIES AND DELIVERY DATES UPON NOTICE TO PROCEED. NO CONSIDERATION WILL BE GIVEN FOR FAILURE TO COMPLY WITH THIS REQUIREMENT. 			FLOOR			BASE	MISC				
<ul style="list-style-type: none"> RENOVATION: THESE SHOULD BE IN FINISH LEGEND AT EXISTING SEALED CONCRETE FLOOR LOCATIONS NOTED AS SC ON FINISH PLANS - GC TO CLEAN, GRIND & RE-SEAL AS SPECIFIED. AREAS WITH CARPET TILE TO BE PATCHED WHERE FLOOR BOXES ARE BEING REMOVED. 		<ul style="list-style-type: none"> FIELD VERIFY ALL DIMENSIONS FOR CASEWORK & MILLWORK PRIOR TO FABRICATION & INSTALLATION ALL EXPOSED ENDS AND EXPOSED INTERIORS OF CASEWORK/MILLWORK TO RECEIVE MATCHING LAMINATES ALL CABINETS TO BE LOCKABLE 					NUMBER	TYPE	DETAIL DESCRIPTION	NUMBER	TYPE	DETAIL DESCRIPTION			
							CPT-1	CARPET	MANUFACTURER: MILLIKEN & COMPANY COLLECTION: SOUTHERN ANALOG DESIGN NAME: VOLTAGE COLOR: VT316 BALANCE SIZE: 178 PEWTER INSTALLATION: LOCATION:	RB-#	RUBBER BASE	MANUFACTURER: ROPPE STYLE NAME: 700 SERIES COLOR: 8283K-05 SIZE: 4"	PL-#	PLASTIC	MANUFACTURER: WILSONART STYLE NAME: WHITE OAT PB HONEY COLOR: 8283K-05 FINISH: TIMBERGRAIN *SPECIFIED BY OWNER
							VCT-1	VINYL COMPOSITION TILE	MANUFACTURER: ARMSTRONG STYLE NAME: STERLING ITEM NUMBER: 51904 SIZE: 12" x 12" INSTALLATION: LOCATION:	SS-1	SOLID SURFACE	MANUFACTURER: WILSONART STYLE NAME: DESIGNER WHITE COLOR: D3545L *SPECIFIED BY OWNER			
							SC-1	SEALED CONCRETE		PNT-1	[GENERAL/MAIN PAINT]	MANUFACTURER: SHERWIN WILLIAMS COLOR: STERLING COIN #8782 TYPE: LATEX LOCATION: ALL WALLS			
										PNT-2	[TRIM/ FRAME PAINT]	MANUFACTURER: SHERWIN WILLIAMS COLOR: STERLING COIN #8782 TYPE: LATEX LOCATION: TRIM/ FRAMES			
												CEILING			
							ACT-1	ACOUSTIC CEILING TILE	MANUFACTURER: USG STYLE NAME: RADAR 2210 COLOR: WHITE SIZE: 24X24 GRID: DX®/DXL™ 15/16" LOCATION: ALL NEW WORK						

ROOM FINISH SCHEDULE							
ROOM #	ROOM NAME	FLOOR	BASE	WALL	MILLWORK/CASEWORK		COMMENTS
					CABINET	COUNTERTOP	
R3	CONFERENCE	CPT-1	RB-1	PNT-1			
R4	OFFICE	CPT-1	RB-1	PNT-1			
R5	OFFICE	CPT-1	RB-1	PNT-1			
R6	OFFICE	CPT-1	RB-1	PNT-1			
R7	OFFICE	CPT-1	RB-1	PNT-1			
R8	HALLWAY	CPT-1	RB-1	PNT-1			
R9	COLLABORATION	CPT-1	RB-1	PNT-1			
R10	OPEN OFFICE	CPT-1 / VCT-1	RB-1	PNT-1	PL-1	SS-1	
R11	ADMIN	CPT-1	RB-1	PNT-1			
R12	ELEC	CPT-1	RB-1	PNT-1			
R13	CORRIDOR	VCT-1	RB-1	PNT-1			PAINT WALLS AND DOOR FRAMES AND PAINT/ STAIN EXISTING DOORS ON HALL SIDE ONLY

ADD ALTERNATE #

CASEWORK SCHEDULE

NOTE: CABINET DESIGN SERIES (CDS) NUMBERS BASED ON AVI STANDARDS EDITION 2

E

B

A

B

C

D

E

F

G

H

I

J

K

L

M

N

O

P

Q

R

S

T

U

V

W

X

Y

Z

FINISH LEGEND		
FLOOR		
NUMBER	TYPE	DETAIL DESCRIPTION
CPT-1	CARPET	MANUFACTURER: MILLIKEN & COMPANY COLLECTION: SOUTHERN ANALOG DESIGN NAME: VOLTAGE COLOR: VT316 BALANCE SIZE: 178 PEWTER INSTALLATION: LOCATION:
VCT-1	VINYL COMPOSITION TILE	MANUFACTURER: ARMSTRONG STYLE NAME: STERLING ITEM NUMBER: 51904 SIZE: 12" x 12" INSTALLATION: LOCATION:
SC-1	SEALED CONCRETE	
ACT-1	ACOUSTIC CEILING TILE	MANUFACTURER: USG STYLE NAME: RADAR 2210 COLOR: WHITE SIZE: 24X24 GRID: DX®/DXL™ 15/16" LOCATION: ALL NEW WORK

BASE		
NUMBER	TYPE	DETAIL DESCRIPTION
RB-#	RUBBER BASE	MANUFACTURER: ROPPE STYLE NAME: 700 SERIES COLOR: 8283K-05 SIZE: 4"
PNT-1	[GENERAL/MAIN PAINT]	MANUFACTURER: SHERWIN WILLIAMS COLOR: STERLING COIN #8782 TYPE: LATEX LOCATION: ALL WALLS

MISC		
PL-#	PLASTIC	MANUFACTURER: WILSONART STYLE NAME: WHITE OAT PB HONEY COLOR: 8283K-05 FINISH: TIMBERGRAIN *SPECIFIED BY OWNER

GMC

Goodwyn Mills Cawood, LLC
117 Welborn Street
Greenville, SC 29601
T 864-527-0460
GMC NETWORK.COMISSUE DATE
06/23/2025
BID DOCUMENTS
1
ADDENDUM
08/17/2025
DRAWN BY
CRG
CHECKED BY
JDBSCC - GAINES BUILDING OFFICE RENOVATION
131 COMMUNITY COLLEGE DRIVE,
SPARTANBURG, SC 29303
GMC # ACST250006STATE OF SOUTH CAROLINA
GOODWYN MILLS CAWOOD, LLC
GREENVILLE, SC
No. 101713
REGISTERED ARCHITECT
JOSHUA DAVID BAGWELL
Charleston, SC
No. 9004
REGISTERED ARCHITECTFINISH LEGEND &
SCHEDULE
A8.01

TEMPLATE VERSION: 2022.1

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